


H:\DRAWINGS\TILE - THE LEARNING EXPERIENCE\TILE - VIRGINIA\TLEVA23-034 - TLE WINCHESTERVA 2600 PLEASANT VALLEY WAY\CD\STILEVA23-034-S-101-FOUNDATION PLAN.DWG RELINAJUAR PLOTTED: 12/19/2023

- NOTES:**
- TOP OF SLAB IS SET AS DATUM 0'-0" AND IS ACTUAL ELEVATION 727.30'
 - SLAB ON GRADE SHALL BE 4" NORMAL WEIGHT CONCRETE PLACED OVER A 10 MIL. VAPOR BARRIER ON 4" CRUSHED STONE. REINFORCE WITH 6x6-W1.4xW1.4 WELDED WIRE FABRIC OR 1.5 POUNDS FIBER REINFORCEMENT PER CUBIC YARD OF CONCRETE AT CONTRACTOR'S DISCRETION. PROVIDE SUBMITTAL FOR W.W.F. OR CONCRETE MIX DESIGN WITH FIBER REINFORCEMENT INCLUDED. SEE ARCHITECTURAL DRAWINGS FOR SCHEDULE OF FINISHES ON ALL EXPOSED CONCRETE SURFACES.
 - FOOTINGS ARE DESIGNED TO BEAR ON UNDISTURBED VIRGIN SOIL OR STRUCTURAL COMPACTED FILL PLACED OVER UNDISTURBED VIRGIN SOIL HAVING A MINIMUM ALLOWABLE BEARING CAPACITY OF 2500 PSF.
 - BOTTOM OF FOOTING ELEVATIONS ARE NOTED THUS 'X'-X" ON PLAN, REFERENCED FROM DATUM. ALL EXTERIOR FOOTINGS SHALL BE A MINIMUM 2'-6" BELOW FINISHED GRADE. TOP OF COLUMN FOOTINGS TO ALIGN WITH TOP OF WALL FOOTINGS.
 - PX - INDICATES PIER TYPE. SEE PIER SCHEDULE FOR SIZE AND REINFORCING. TOP OF PIER ELEVATIONS ARE '-0'-8" UNLESS NOTED THUS '-X'-X" ON PLAN, REFERENCED FROM DATUM.
 - FX-X - INDICATES COLUMN FOOTING TYPE. SEE FOOTING SCHEDULE FOR SIZE AND REINFORCING.
 - SW-X INDICATES SHEAR WALL LOCATION. SEE SHEAR WALL SCHEDULE ON S-103.
 - ▶ INDICATES SHEAR WALL HOLDDOWN LOCATION. SEE SHEAR WALL SCHEDULE ON S-103 FOR SIZE AND ANCHORAGE.
 - FOR GENERAL NOTES, SEE DRAWING S-100.
 - FOR TYPICAL DETAILS, SEE DRAWING S-200.
 - * COORDINATE LOCATION OF POSTS WITH APPROVED ROOF TRUSS SHOP DRAWINGS.

PIER SCHEDULE					
MARK	SIZE		REINFORCING		REMARKS
	LENGTH	WIDTH	VERT.	TIES	
P1	20"	20"	4 - #7	#4 @ 12"	
P2	18"	18"	4 - #6	#4 @ 12"	

COLUMN SCHEDULE		
MARK	SIZE AND MATERIAL	BASE CONNECTION REQUIREMENTS
C1	HSS 8x3x3/8	BASE PL - 12"x9"x3/4" W/ (4) 3/4"Ø F1554 ANCHOR RODS, EMBED. 1'-0"
C2	HSS 6x3x1/2	BASE PL - 12"x9"x3/4" W/ (4) 3/4"Ø F1554 ANCHOR RODS, EMBED. 1'-0"
C3	HSS 6x3x1/2	BASE PL - 12"x9"x3/4" W/ (4) 3/4"Ø F1554 ANCHOR RODS, EMBED. 1'-0"
C4	HSS 6x3x1/4	BASE PL - 12"x9"x3/4" W/ (4) 3/4"Ø F1554 ANCHOR RODS, EMBED. 1'-0"
C5	5-1/4 x 5-1/4 PSL	BEAR ON WALL BOTTOM PLATE. ATTACH W/ DTT12 W/ 3/8"Ø THREADED ROD W/ HILTI HIT HY200 ADHESIVE EMBED 3 3/8" MIN. INTO CONCRETE
C5A	5-1/4 x 5-1/4 PSL	SIMPSON ABU66Z W/ (12) 16d NAILS. ANCHOR TO CONC. W/ 5/8"Ø THREADED ROD IN HILTI HIT-HY200 ADHESIVE EMBED 5 5/8" AT CANOPY POSTS

FOOTING SCHEDULE 2500 PSF BEARING CAPACITY						
MARK	SIZE			BOTT. REINF. E.W. - EACH WAY L-LONG S-SHORT	TOP REINF. E.W. - EACH WAY L-LONG S-SHORT	
	LENGTH	WIDTH	DEPTH			
F3.0	3'-0"	3'-0"	18"	7 - #4 E.W.	-	
F3.5	3'-6"	3'-6"	18"	10 - #5 E.W.	-	
F4.0	4'-0"	4'-0"	18"	11 - #5 E.W.	-	
F4.5	4'-6"	4'-6"	18"	12 - #5 E.W.	-	

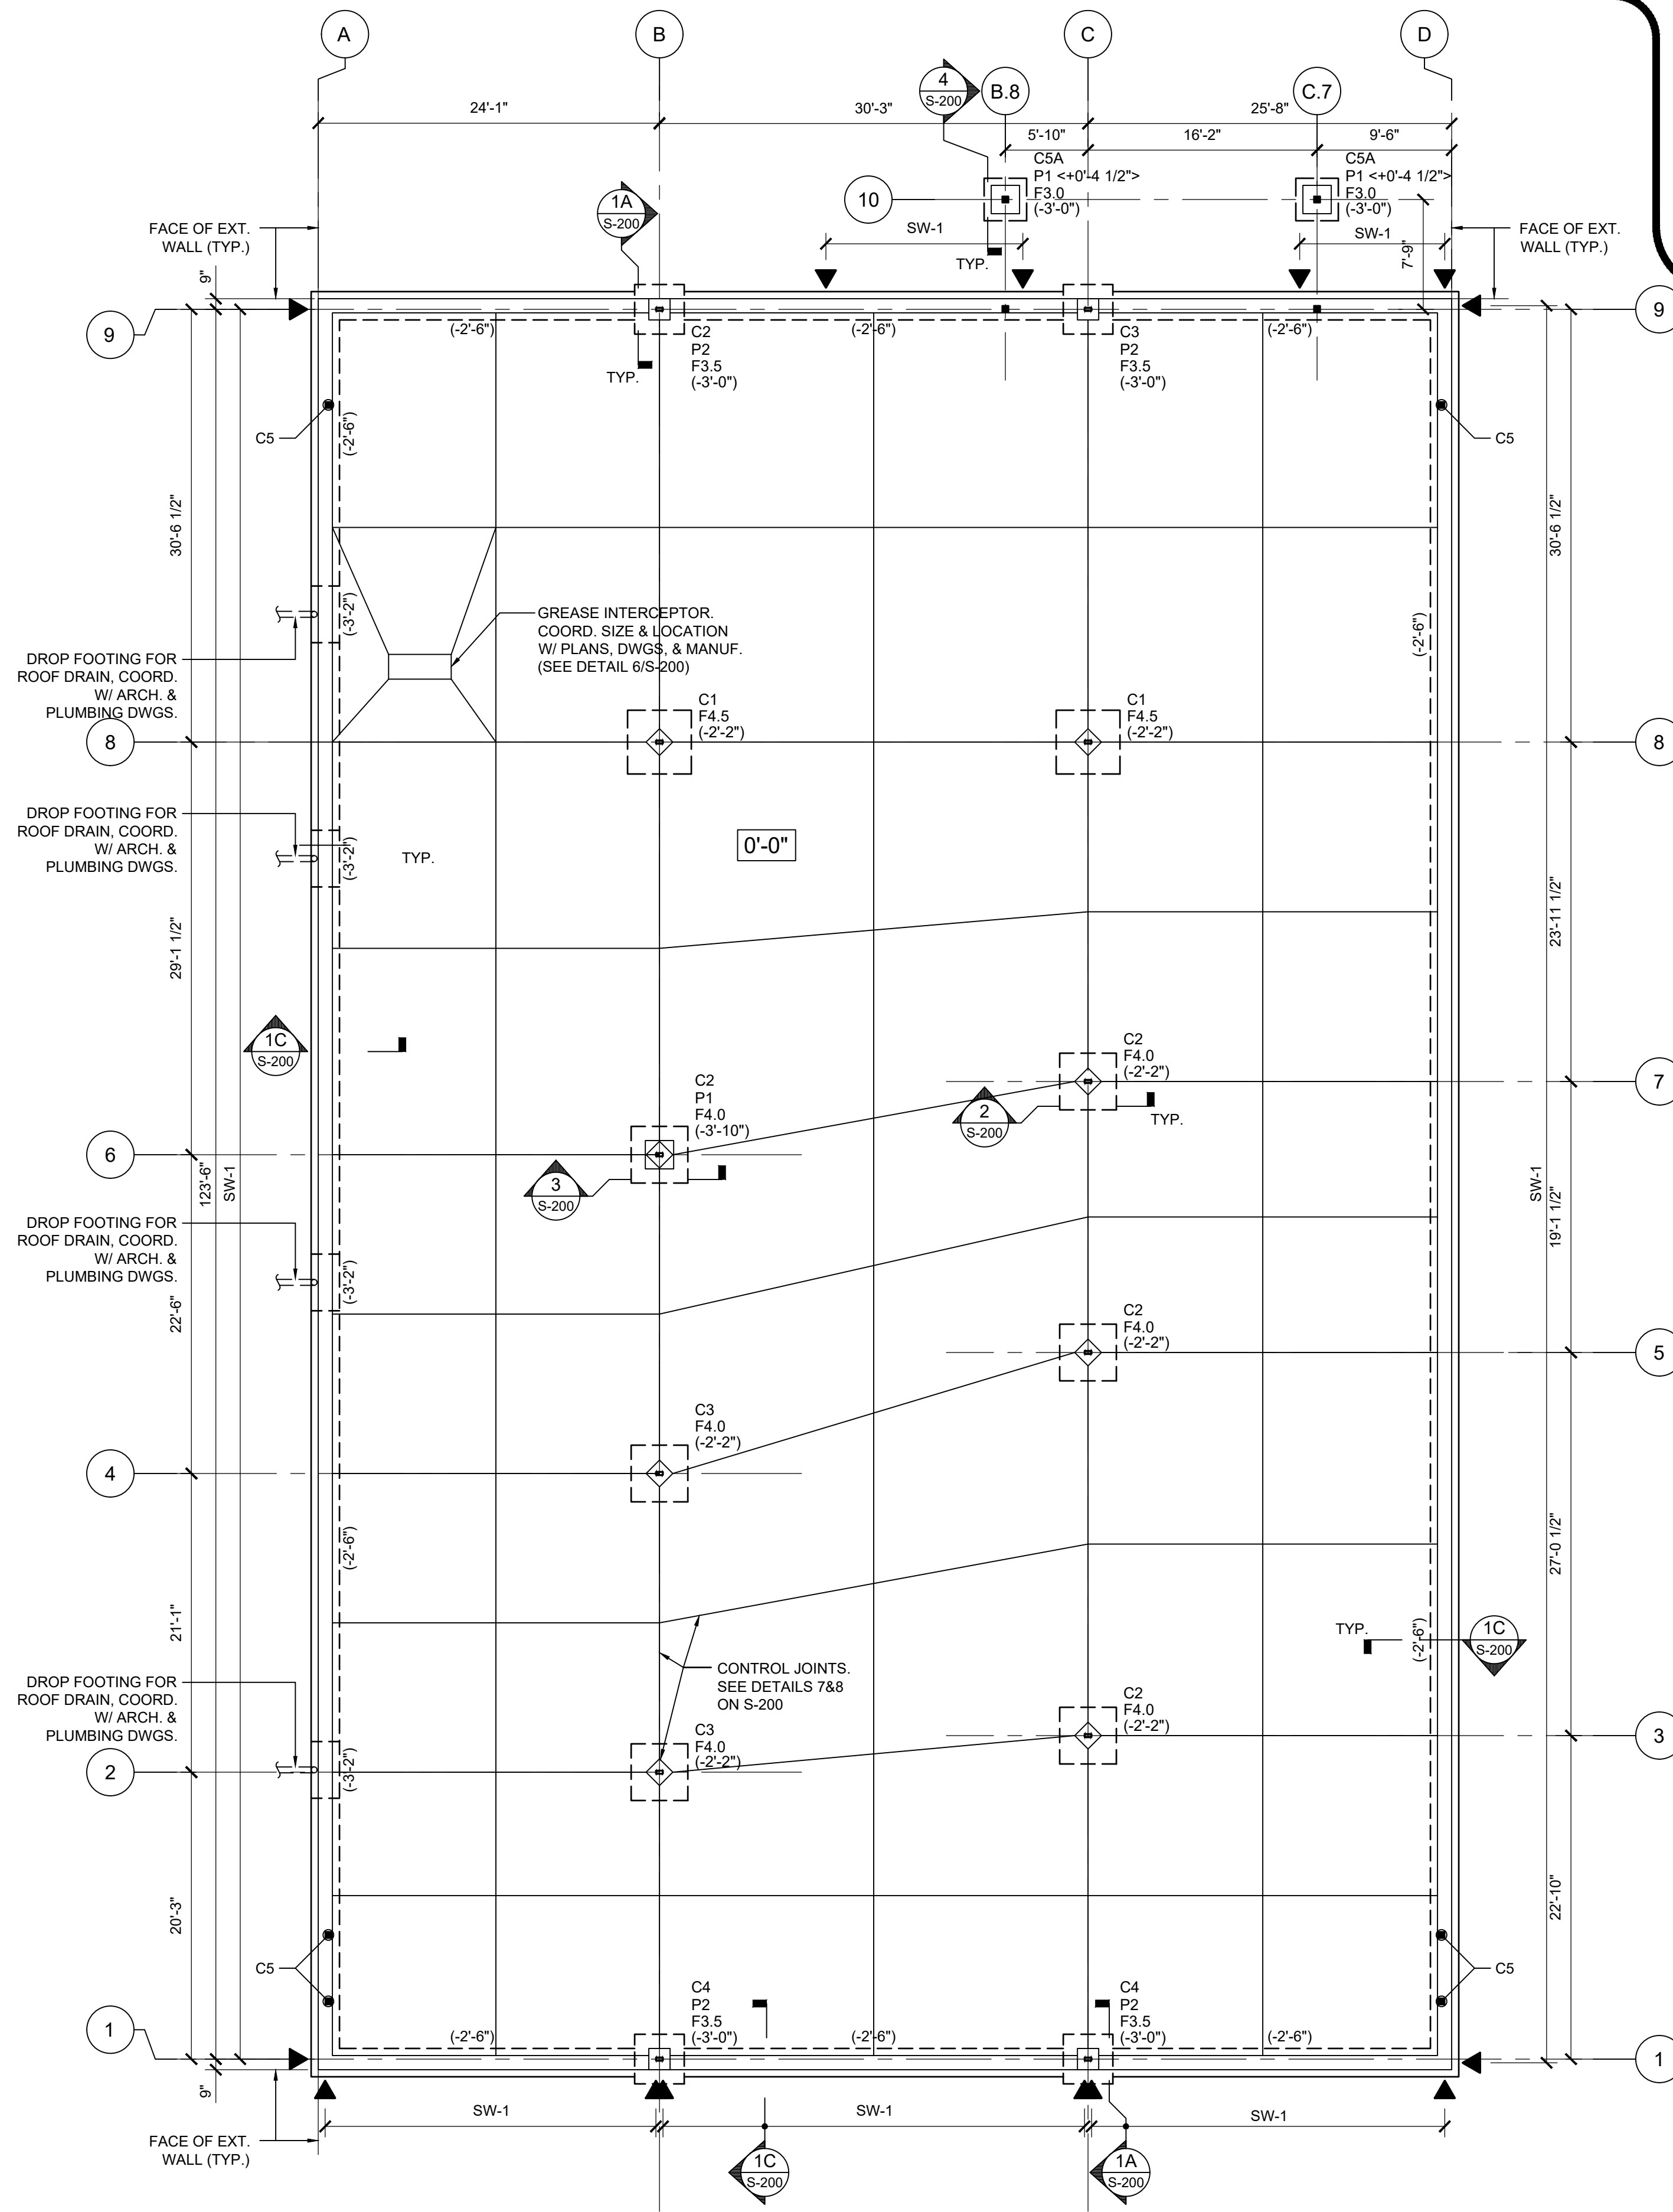

- CONTRACTOR SHALL SUPERVISE AND DIRECT THE WORK USING THE CONTRACTOR'S BEST SKILL AND ATTENTION. THE CONTRACTOR SHALL BE SOLELY RESPONSIBLE AND HAVE CONTROL OVER CONSTRUCTION MEANS, METHODS, TECHNIQUES, SEQUENCE, AND JOB SITE SAFETY.
- GC MUST PROVIDE & INSTALL ALL PRODUCTS PER PLANS. ONLY SUBSTITUTED PRODUCTS NEED TO BE SUBMITTED TO THE ARCHITECT FOR APPROVAL. UNAPPROVED SUBSTITUTIONS WILL BE REPLACED AT THE EXPENSE OF THE GC.
- VERBAL REPRESENTATION HAS NO VALUE AND ALL REQUESTS TO CHANGE ANY PRODUCTS OR SPECIFICATIONS PER PLANS, MUST BE SUBMITTED IN WRITING TO THE ARCHITECT & TLE FOR APPROVAL.

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REVISION			
NO.	DATE	DESCRIPTION	INT.

PROFESSIONAL CERTIFICATION
NAME OF LICENSEE: SHANNON CROWNOVER
LICENSE NUMBER: 0402 06 6228

Project Number: TLEVA23-034	Scale: AS NOTED
Drawn By: R.E.	Approved By: SC

Drawing Name:
FOUNDATION PLAN

Drawing Number:
S-101


SHANNON NICOLE CROWNOVER
Lic. No. 0402066228
PROFESSIONAL ENGINEER

- NOTES:**
- TYPICAL ROOF CONSTRUCTION SHALL BE 3/4" SHEATHING OVER PRE-FABRICATED WOOD TRUSSES.
 - WOOD TRUSSES ARE SUPPORTED BY EXTERIOR BEARING WALLS AND INTERIOR STEEL BEAMS AND SHALL BE BOTTOM CHORD BEARING.
 - BOTTOM OF ROOF TRUSS BOTTOM CHORD (TOP OF BEARING PLATES) IS SET AT ELEVATION +11'-1 1/8". TOP OF ROOF TRUSS TOP CHORD SLOPES, WITH H.P. ELEVATION +14'-8 5/8".
 - ALL STUD WALLS SHOWN ON FRAMING PLAN ARE 2x6 AT 16" O.C. LOAD BEARING WALLS. SEE ARCHITECTURAL DRAWINGS FOR LOCATION AND DETAILS ON INTERIOR NON-LOAD BEARING PARTITION WALLS.
 - EXTERIOR WALLS ARE TO BE SHEATHED WITH 5/8" SHEATHING ANCHORED WITH 10d NAILS AT 6" O.C. AT PANEL EDGES AND 12" O.C. AT INTERMEDIATE SUPPORTS, UNLESS OTHERWISE DESIGNATED ON THE SHEAR WALL SCHEDULE ON S-103.
 - ALL TRUSSES SHALL BE DESIGNED AND FABRICATED PER APPLICABLE LOADS BY THE TRUSS FABRICATOR. SUBMIT SHOP DRAWINGS AND CALCULATIONS SIGNED AND SEALED BY A PROFESSIONAL ENGINEER LICENSED IN THE STATE OF VIRGINIA.
 - ROOF TRUSSES ARE TO BE A DEFERRED SUBMITTAL. SIGNED AND SEALED COPIES OF THE TRUSS CALCULATIONS AND THE PLACEMENT PLANS, WITH EVIDENCE THAT THE ENGINEER OF RECORD HAS REVIEWED AND APPROVED, SHALL BE SUBMITTED TO THE BUILDING DEPARTMENT.
 - TRUSSES ARE TO BE DESIGNED FOR ALL LOADING AS DESIGNATED IN THE LOAD SCHEDULE AND ALL MECHANICAL UNITS SHOWN. COORDINATED LOCATION AND WEIGHTS OF UNITS WITH MECHANICAL DRAWINGS.
 - MECHANICAL EQUIPMENT DIMENSIONS SHOWN ON PLAN ARE TO CENTERLINE OF UNIT. DIMENSIONS TO BE VERIFIED WITH MECHANICAL DRAWINGS AND APPROVED HVAC SHOP DRAWINGS.
 - ALL TRUSSES/ROOF FRAMING ARE TO BE COORDINATED WITH MECHANICAL DRAWINGS FOR ROOF PENETRATIONS AND DUCTWORK LOCATIONS.
 - BM-X - INDICATES BEAM TYPE, SEE BEAM SCHEDULE FOR SIZE AND CONNECTION REQUIREMENTS. TOP OF BEAM ELEVATION NOTED THUS (+X'-X") ON PLAN, REFERENCED FROM BUILDINGS DATUM.
 - H-X - INDICATES HEADER TYPE, SEE HEADER SCHEDULE FOR SIZE AND CONNECTION REQUIREMENTS.
 - SW-X - INDICATES SHEAR WALL. SEE SHEAR WALL SCHEDULE AND SHEAR WALL ELEVATION ON S-103 FOR MORE INFORMATION.
 - ALL BEAMS, HEADERS, AND TRUSSES ARE TO BEAR ON POSTS SHOWN ON PLAN WITH CONNECTIONS AS SPECIFIED IN THE COLUMN SCHEDULE.
 - SEE DRAWING S-100 FOR GENERAL NOTES.
 - UNLESS OTHERWISE NOTED ON PLAN, PROVIDE A (2) 2x6 POST AT ALL 2-PLY GIRDER TRUSS AND A (3) 2x6 POST AT ALL 3-PLY GIRDER TRUSS. GC SHALL COORDINATE LOCATION AND SIZE OF POST WITH APPROVED ROOF TRUSS SHOP DRAWINGS.

LOAD SCHEDULE	
ROOF DEAD LOAD:	
WOOD TRUSSES	5 PSF
3/4" PLYWOOD	3 PSF
ROOFING/ASPHALT SHINGLES	3 PSF
CEILING/INSULATION	3 PSF
MEP/MISC.	6 PSF
TOTAL DEAD LOAD	20 PSF
	+ WEIGHT OF UNITS
LIVE LOAD	20 PSF
APPLY 10 PSF OF DL TO TRUSS BOTTOM CHORD	
DESIGN FLAT ROOF SNOW LOAD	27 PSF*

* GROUND SNOW LOAD TO BE ADJUSTED FOR DRIFT, SLIDING, UNBALANCED LOADING, ETC. PER CODE.

HEADER SCHEDULE				
MARK	LOCATION	HEADER SIZE	JAMB MEMBER	HEADER CONNECTION
H-1	SINGLE DOOR / WINDOW 4'-0" MAXIMUM OPNG.	3-2x10 W/ 2-1/2" PLYWOOD SPACERS	2-2x6 EACH SIDE	SIMPSON A21 & LSTA9
H-2	DOUBLE DOOR / WINDOW 8'-0" MAXIMUM OPNG.	3-2x12 W/ 2-1/2" PLYWOOD SPACERS	2-2x6 EACH SIDE	SIMPSON A21 & LSTA9

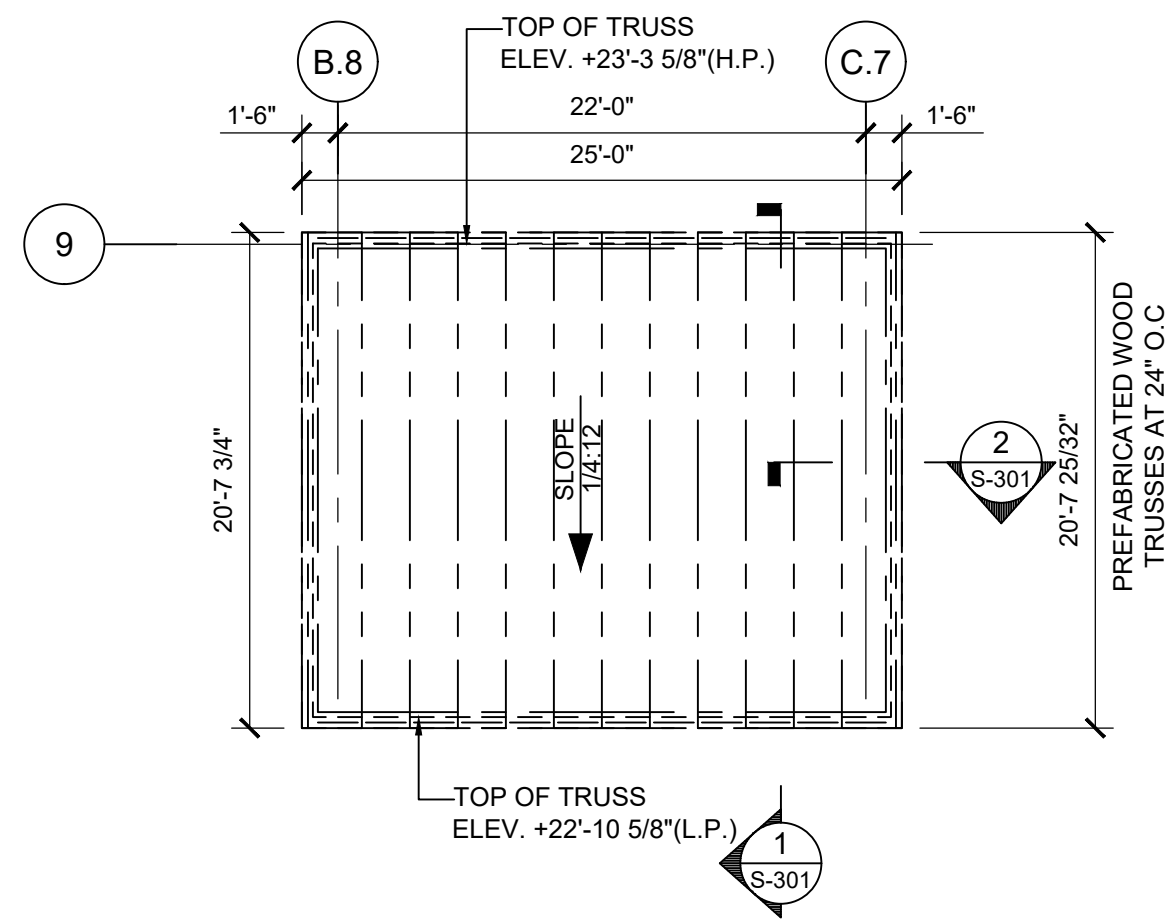


CANOPY ROOF FRAMING PLAN

SCALE: 1/8" = 1'-0"

NOTES:

- TYPICAL ROOF CONSTRUCTION SHALL BE 3/4" SHEATHING OVER PRE-FABRICATED WOOD TRUSSES.
- WOOD TRUSSES ARE SUPPORTED BY ROOF TRUSSES BELOW AND SHALL BE BOTTOM CHORD BEARING.
- TOP OF ROOF TRUSS HIGH POINT TO BE ELEVATION +23'-3 5/8". SLOPE TOP CHORD OF TRUSS MINIMUM 1/4" PER FOOT. TOP OF TRUSS LOW POINT TO BE ELEVATION +22'-10 5/8".

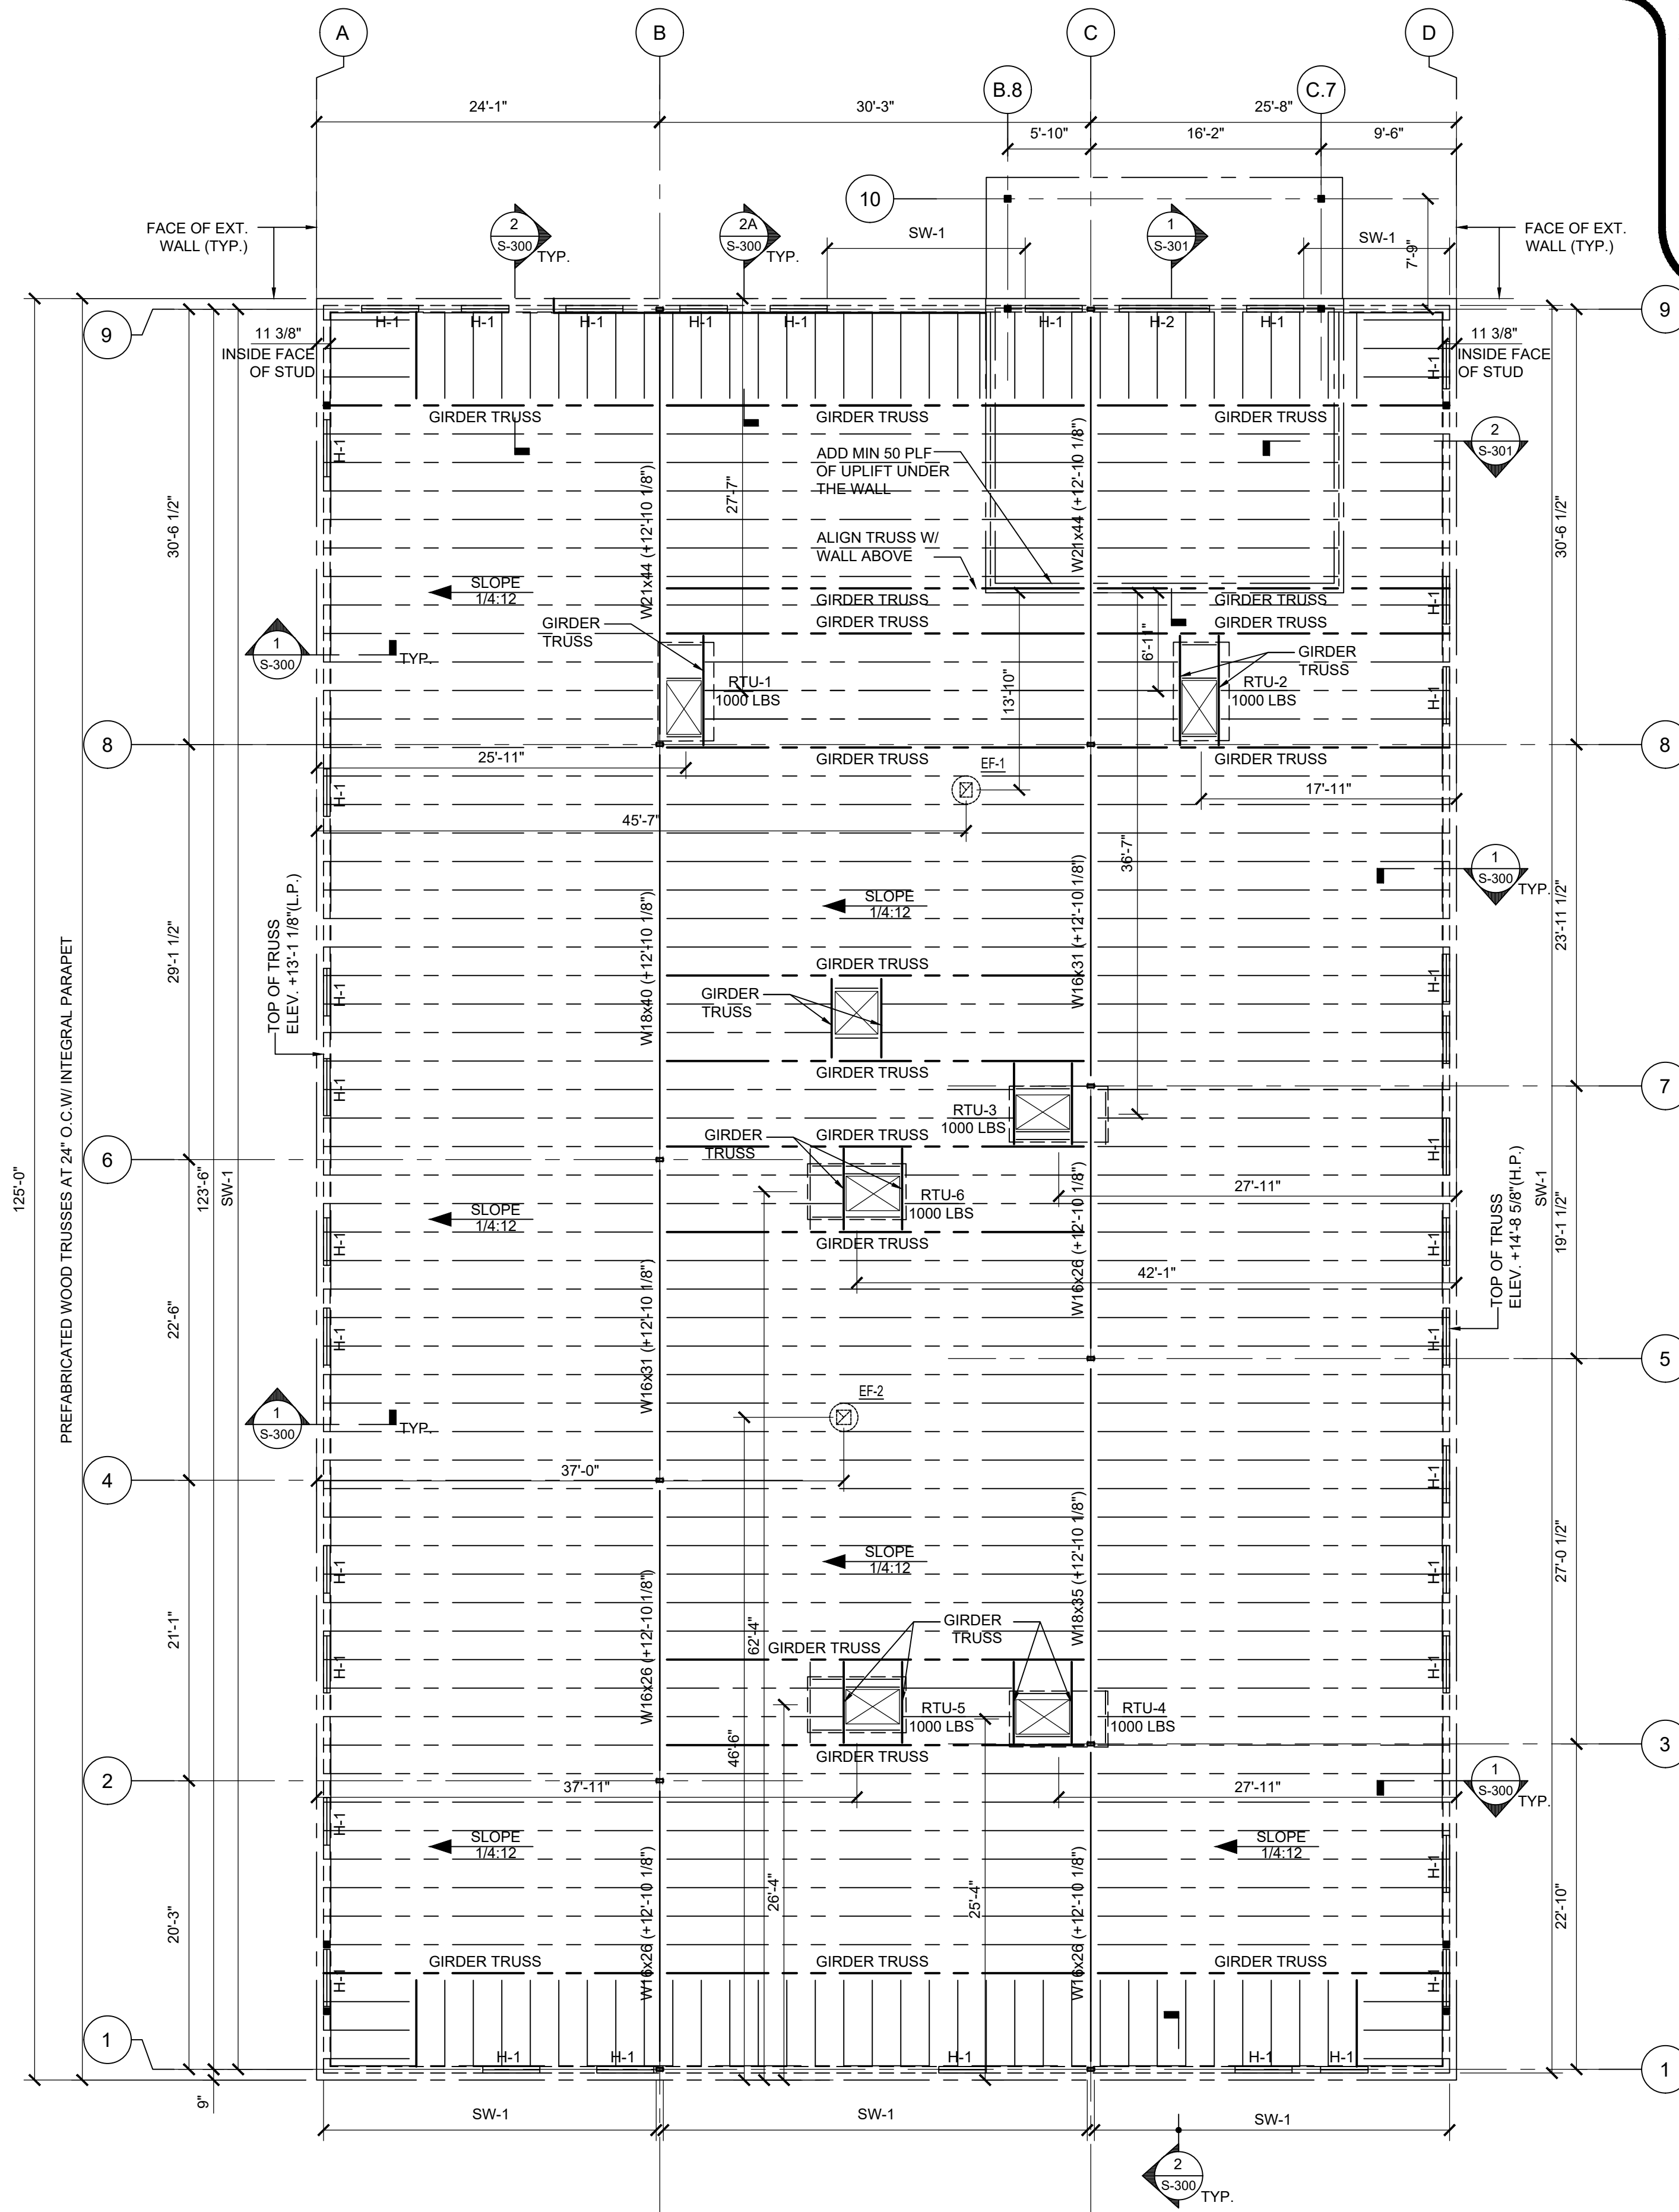

ROOF FRAMING PLAN

SCALE: 1/8" = 1'-0"

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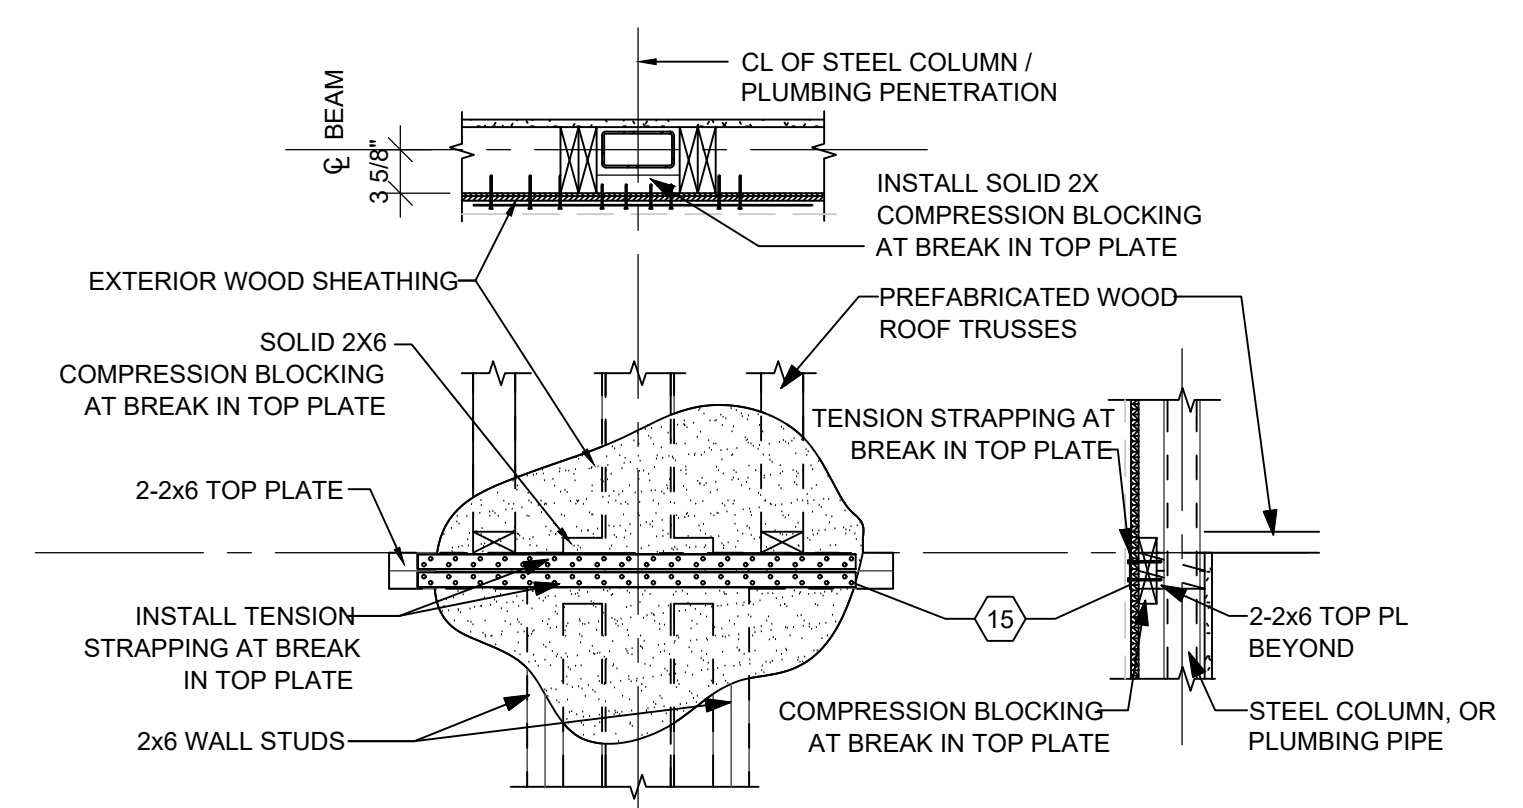
PROFESSIONAL CERTIFICATION
NAME OF LICENSEE: SHANNON
CROWNOWER
LICENSE NUMBER: 0402 06 6228

Project Number: TLEVA23-034
Scale: AS NOTED
Drawn By: R.E.
Approved By: SC


Drawing Name: **ROOF FRAMING PLAN**

Drawing Number: S-102


DRAWINGS TITLE: THE LEARNING EXPERIENCE, VIRGINIA TLEVA23-034 - TLE WINCHESTERVA 2600 PLEASANT VALLEY WAY CD STILEVA23-034-S-103-WALL ELEVATIONS DWG. RELMAJUR PLOTTED: 12/19/2023




10 TYPICAL TOP PLATE TENSION TIE
SCALE : 3/4" = 1'-0"

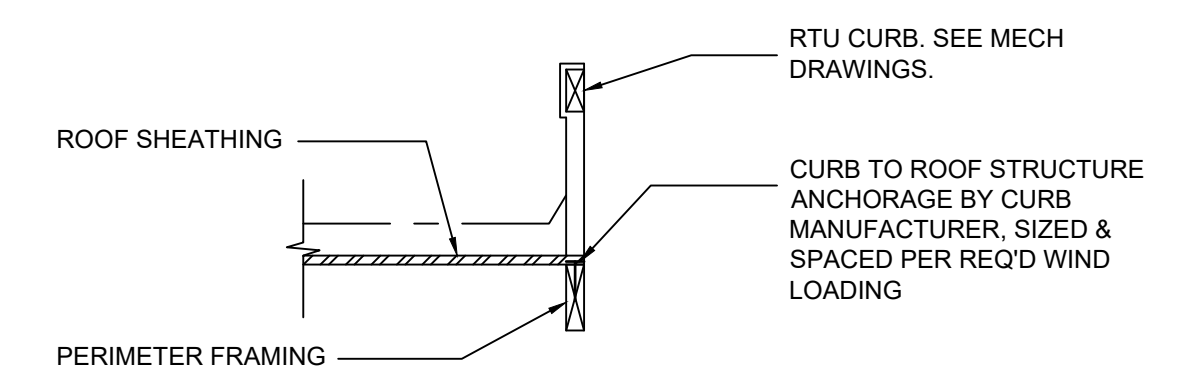


9 TYPICAL RTU CURB SECTION
SCALE : 3/4" = 1'-0"

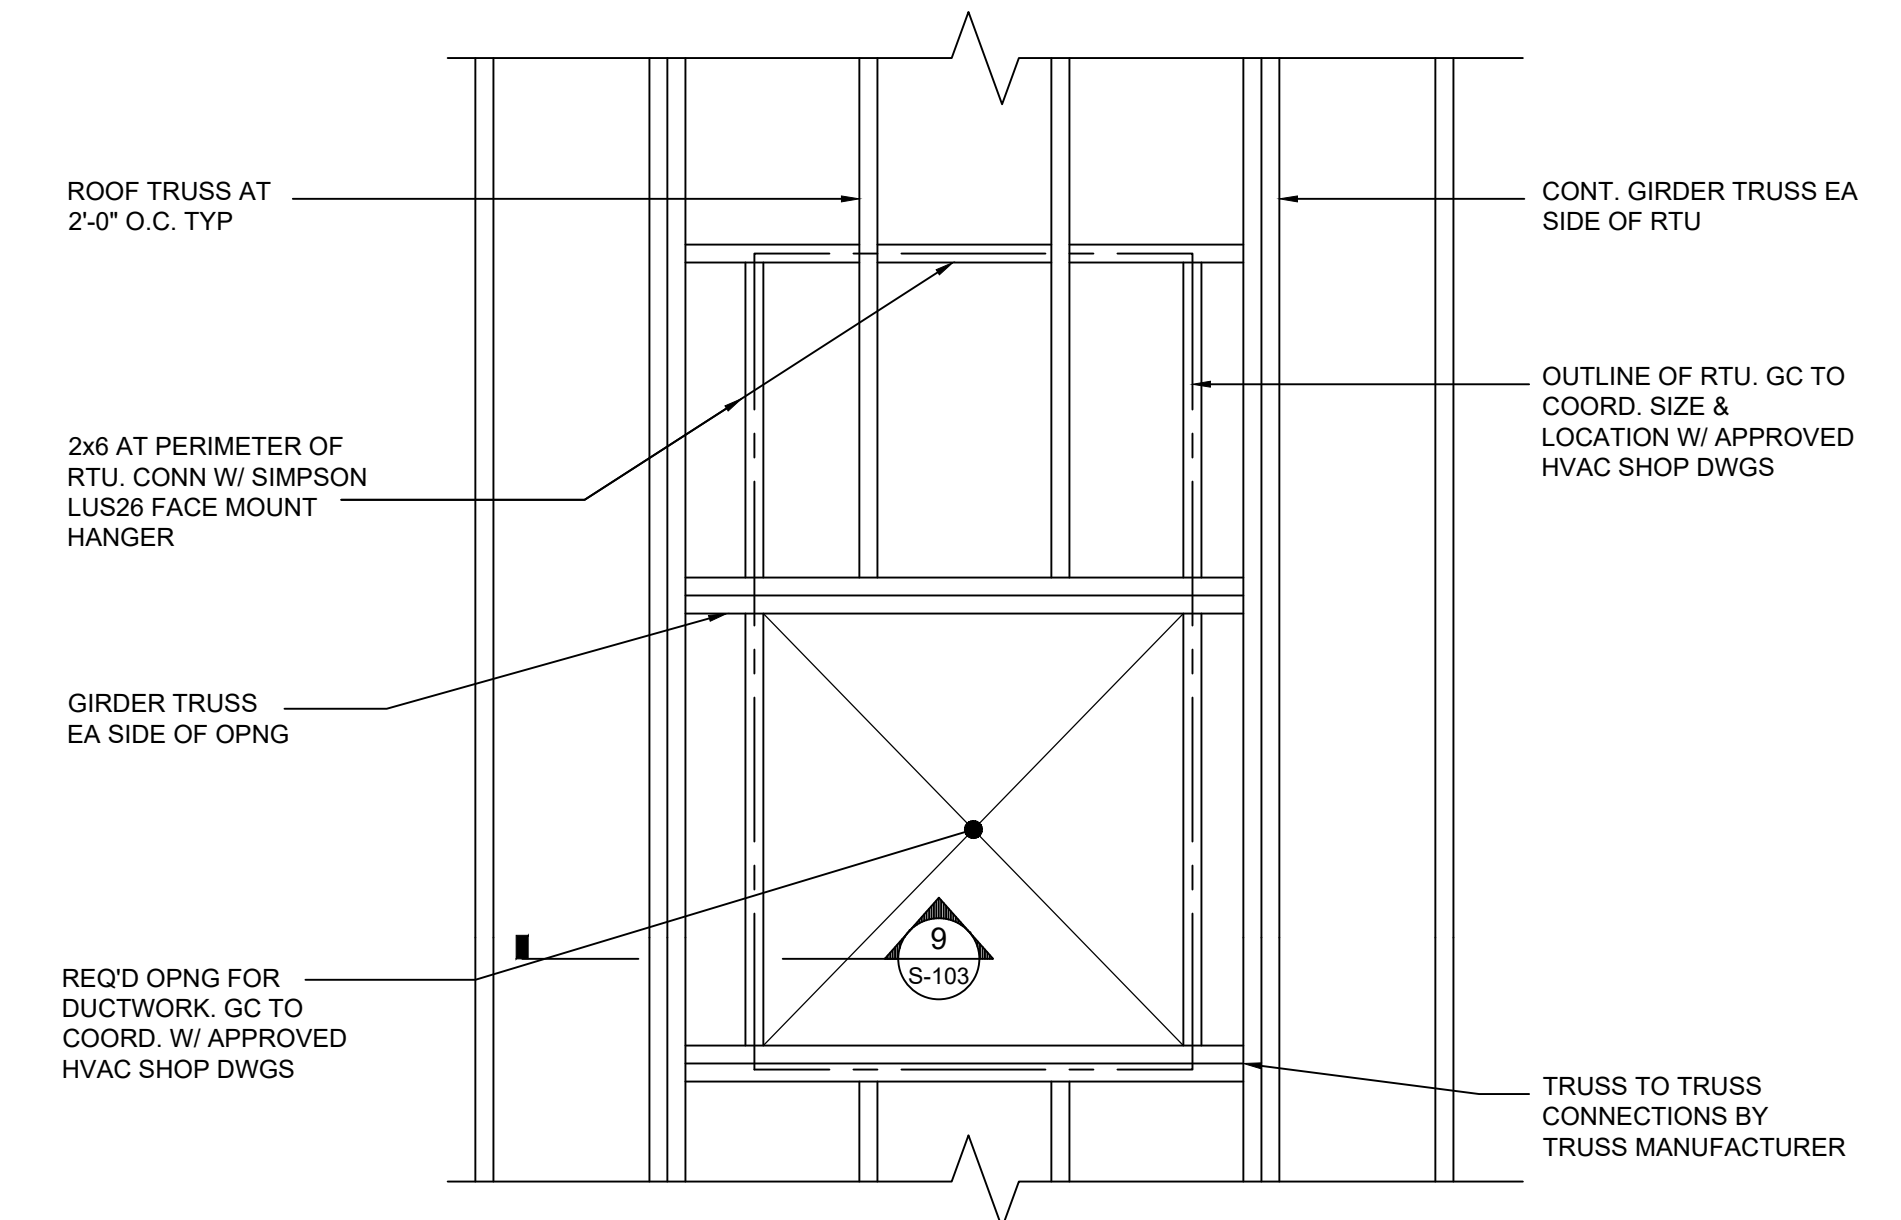


8 TYPICAL RTU CURB DETAIL
SCALE : 3/4" = 1'-0"

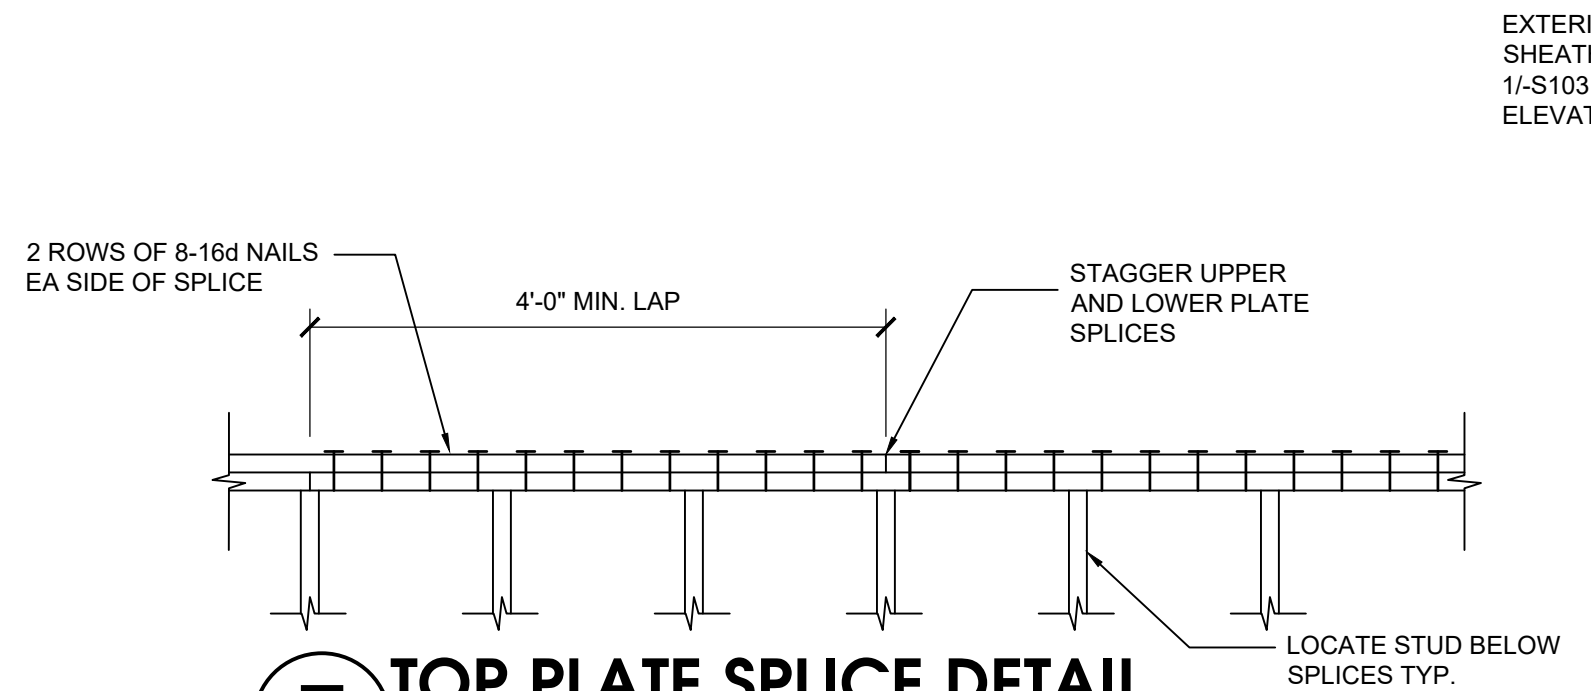

7 TOP PLATE SPLICE DETAIL
SCALE : 3/4" = 1'-0"

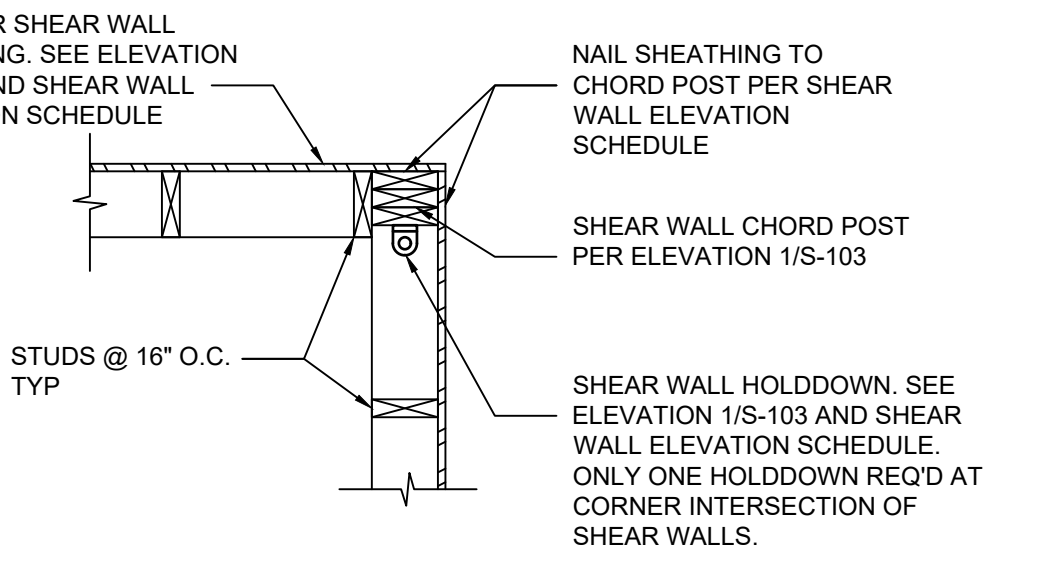


6 SHEAR WALL CORNER HOLDDOWN PLAN DETAIL
SCALE : 3/4" = 1'-0"

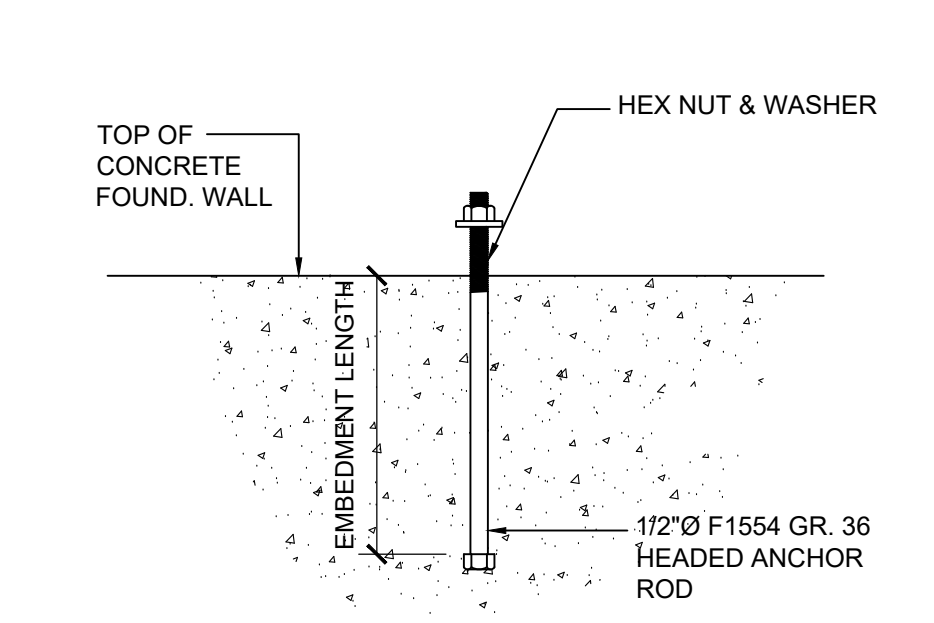


5 TYPICAL SILL ANCHOR DETAIL
SCALE : N.T.S.


#	ITEM DESCRIPTION	REMARKS
1	SIMPSON HDU2-SDS2.5 IN MINIMUM 3 INCH MEMBER W/ SIMPSON SB5@X24 ANCHOR BOLT, EMBED 18 INCHES	AT LOCATION MARKED ON PLAN
2	1/2" Ø F1554 GR. 36 HEADED ANCHOR RODS @ 4 FT O.C., & WITHIN 12" OF SILL PL ENDS OR 1/2" Ø SIMPSON TITEN HD SCREW ANCHOR @ 4'-0" O.C. & WITHIN 12" OF SILL PL ENDS	9" EMBEDMENT FOR HEADED ANCHOR 3 5/8" EMBEDMENT FOR SCREW ANCHOR PROVIDE W/ 3" x 3" x 1/4" PL ON SILL FOR BOTH CAST-IN & POST-INSTALLED ANCHORS
3	SIMPSON H2.5T	(9) 10d X 1 1/2" TO TRUSS (6) 10d X 1 1/2" TO PLATES AT EACH TRUSS
4	NOT USED	
5	SIMPSON LGT2 (FOR 2-PLY GIRDER TRUSS) SIMPSON LGT3 (FOR 3-PLY GIRDER TRUSS)	LGT2- 14-16d SINKERS TO POST 16-16d SINKERS TO GIRDER TRUSS LGT3- 26-16d SINKERS TO POST 12-SDS 1/4"x2 1/2" TO GIRDER TRUSS
6	SIMPSON SP2	6-10d X 1 1/2" TO STUD, 6-10d PLATES EVERY OTHER STUD
7	2-16d COMMON NAILS	END NAIL TOP PLATE TO STUD, TYP.
8	4-8d COMMON NAILS	TOE NAIL STUD TO SOLE PLATE, TYP
9	SIMPSON SP1	6-10d X 1 1/2" TO STUD, 6-10d PLATES EVERY OTHER STUD. USE HDG NAILS MEETING ASTM A153
10	5/8" SHEATHING	EXTERIOR FACE ONLY
11	10d COMMON NAILS @ 6" O.C. AT LOCATIONS MARKED SW-1	AT PANEL EDGES. SPACING TO BE 12" O.C. AT INTERMEDIATE SUPPORTS, 1 1/2" EMBED. MIN. IN STUD/BLOCKING, TYP.
12	SIMPSON LSTA9	4-10d EACH TO STUD AND HEADER, 8-10d TOTAL
13	SIMPSON A21	2-10d X 1 1/2" TO HEADER/ SILL 2-10d X 1 1/2" TO JAMB
14	SIMPSON CCO66SDS2.5	16 SDS 1/4"x2 1/2" SCREWS TO BEAM 14 SDS 1/4"x2 1/2" SCREWS TO POST
15	(2)CS20 W/ 6" END LENGTHS	(12) 0.148 x 2 1/2" FASTENERS AT EA. STRAP

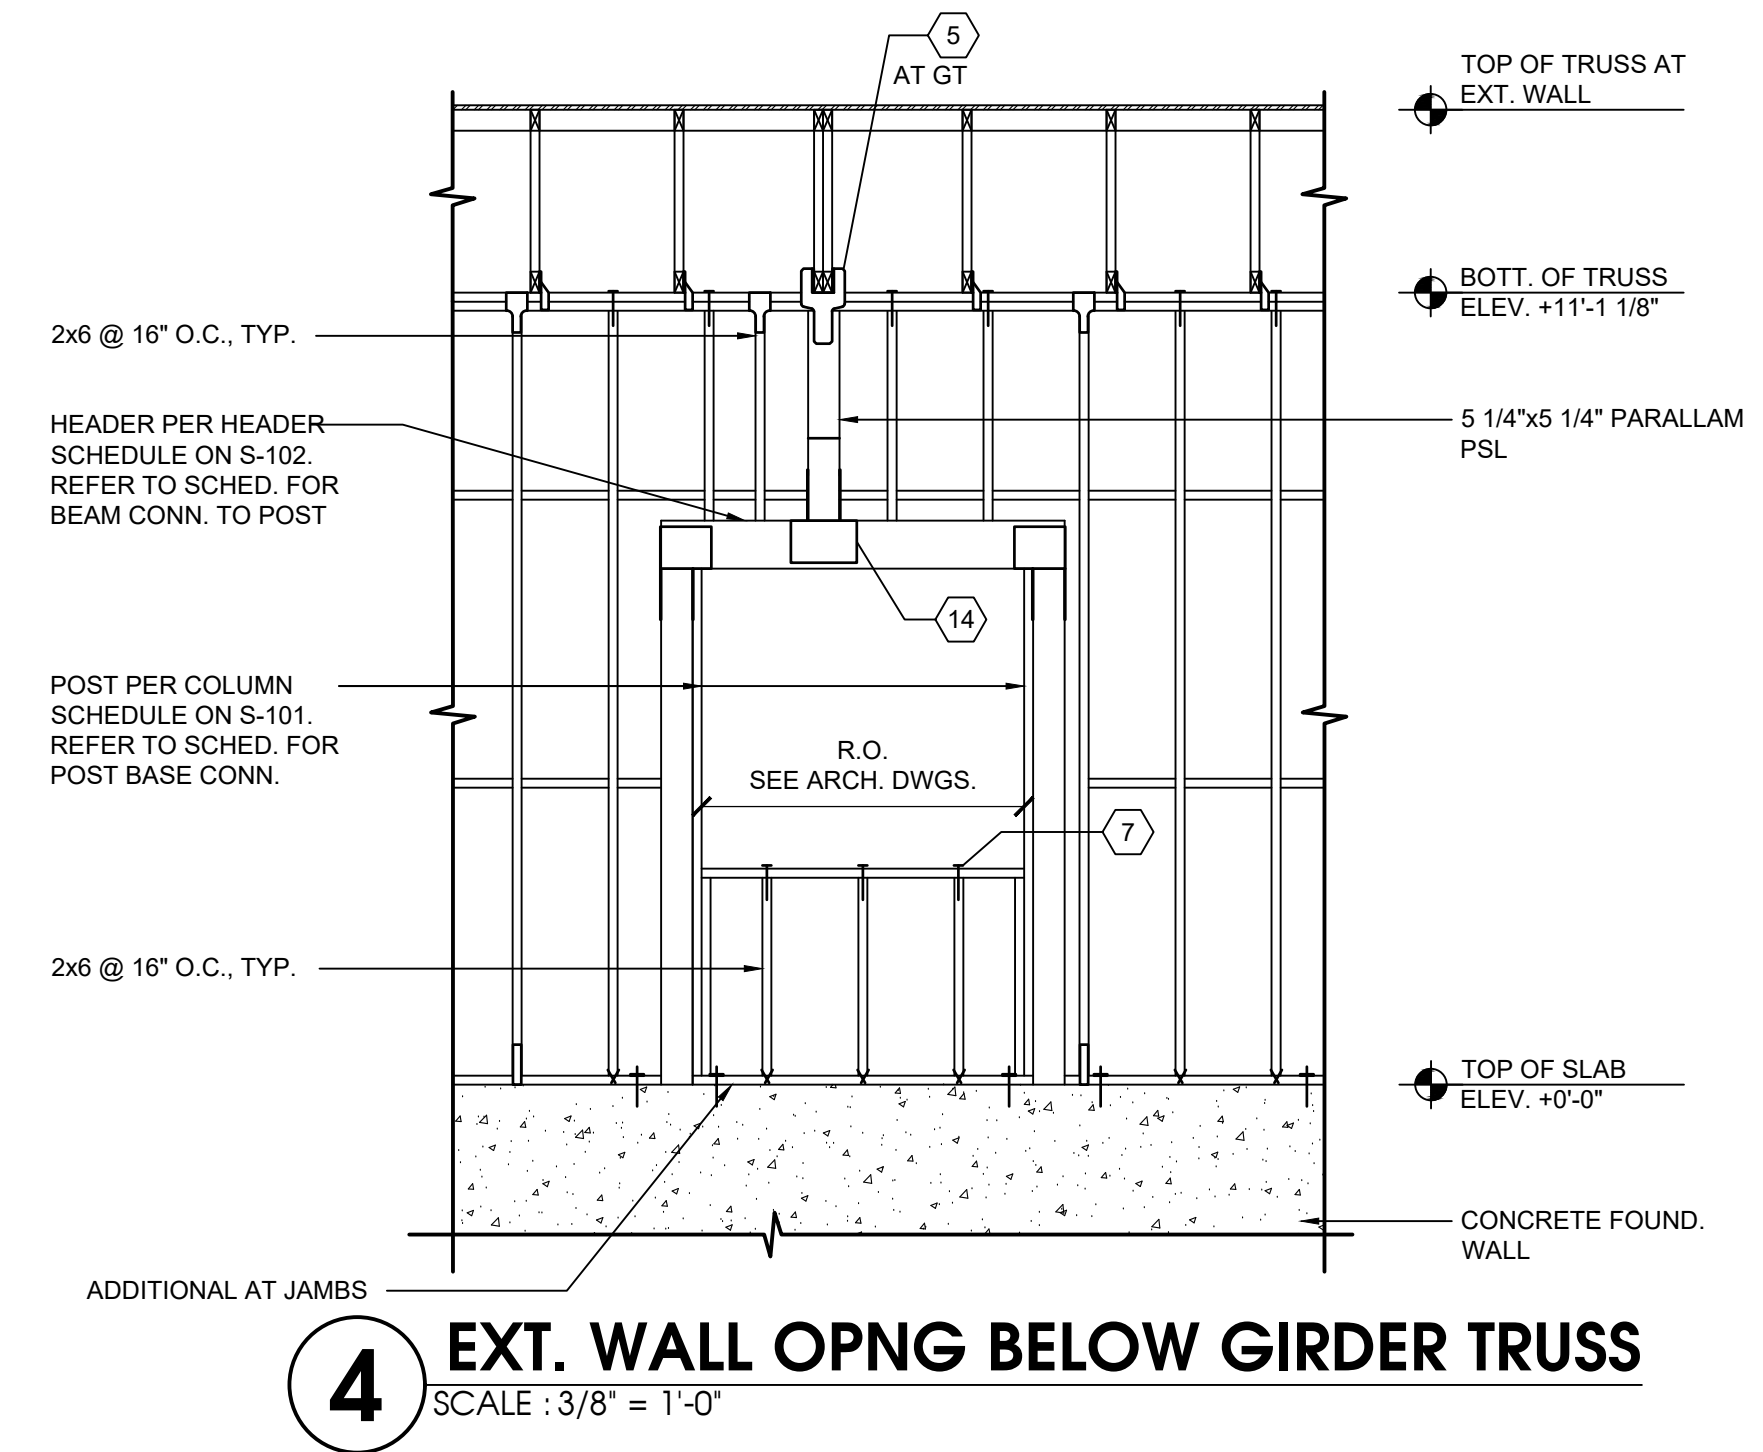


4 EXT. WALL OPNG BELOW GIRDER TRUSS
SCALE : 3/8" = 1'-0"

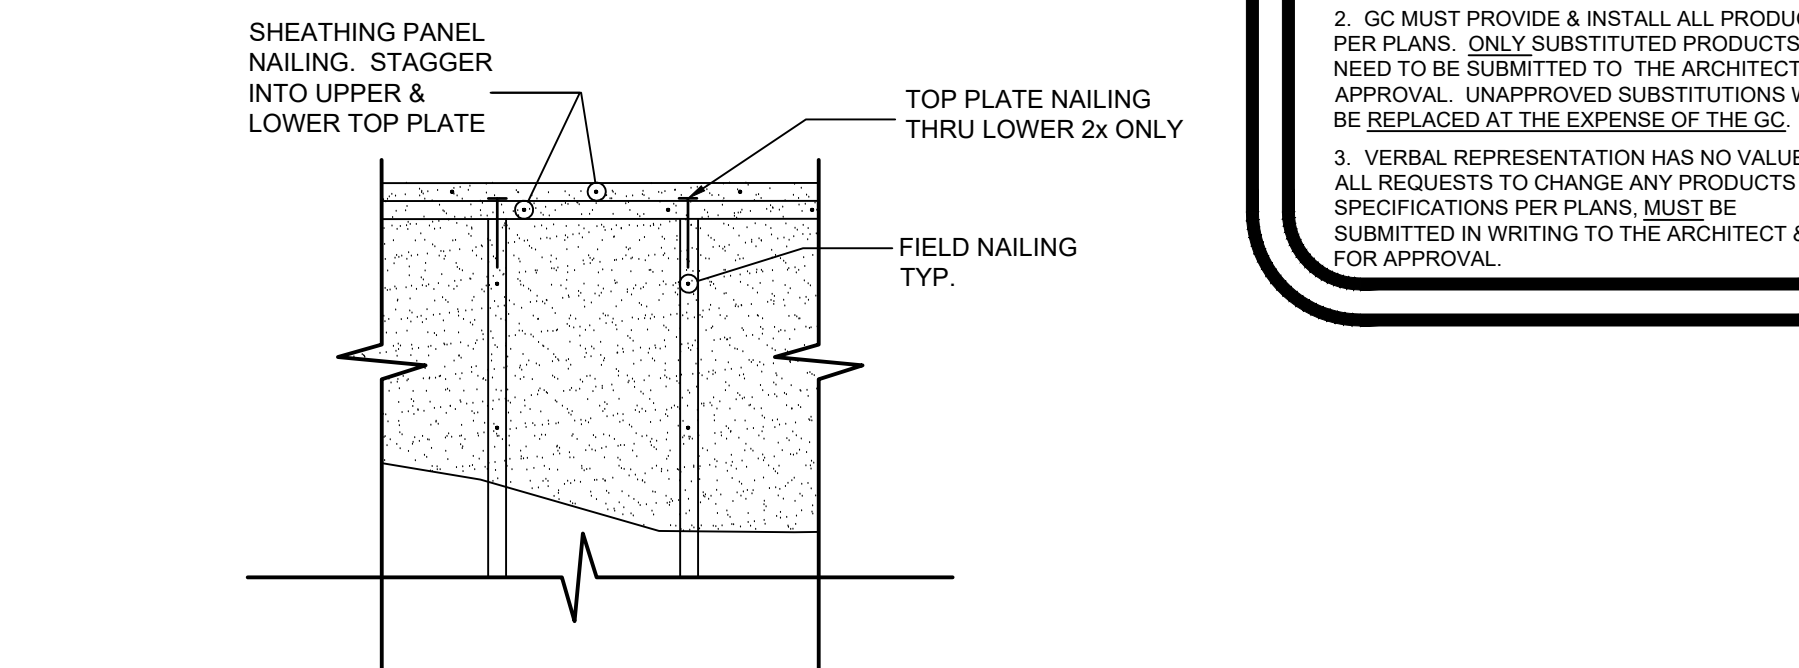

3 NAILING DETAIL AT TOP PLATE
SCALE : 3/4" = 1'-0"

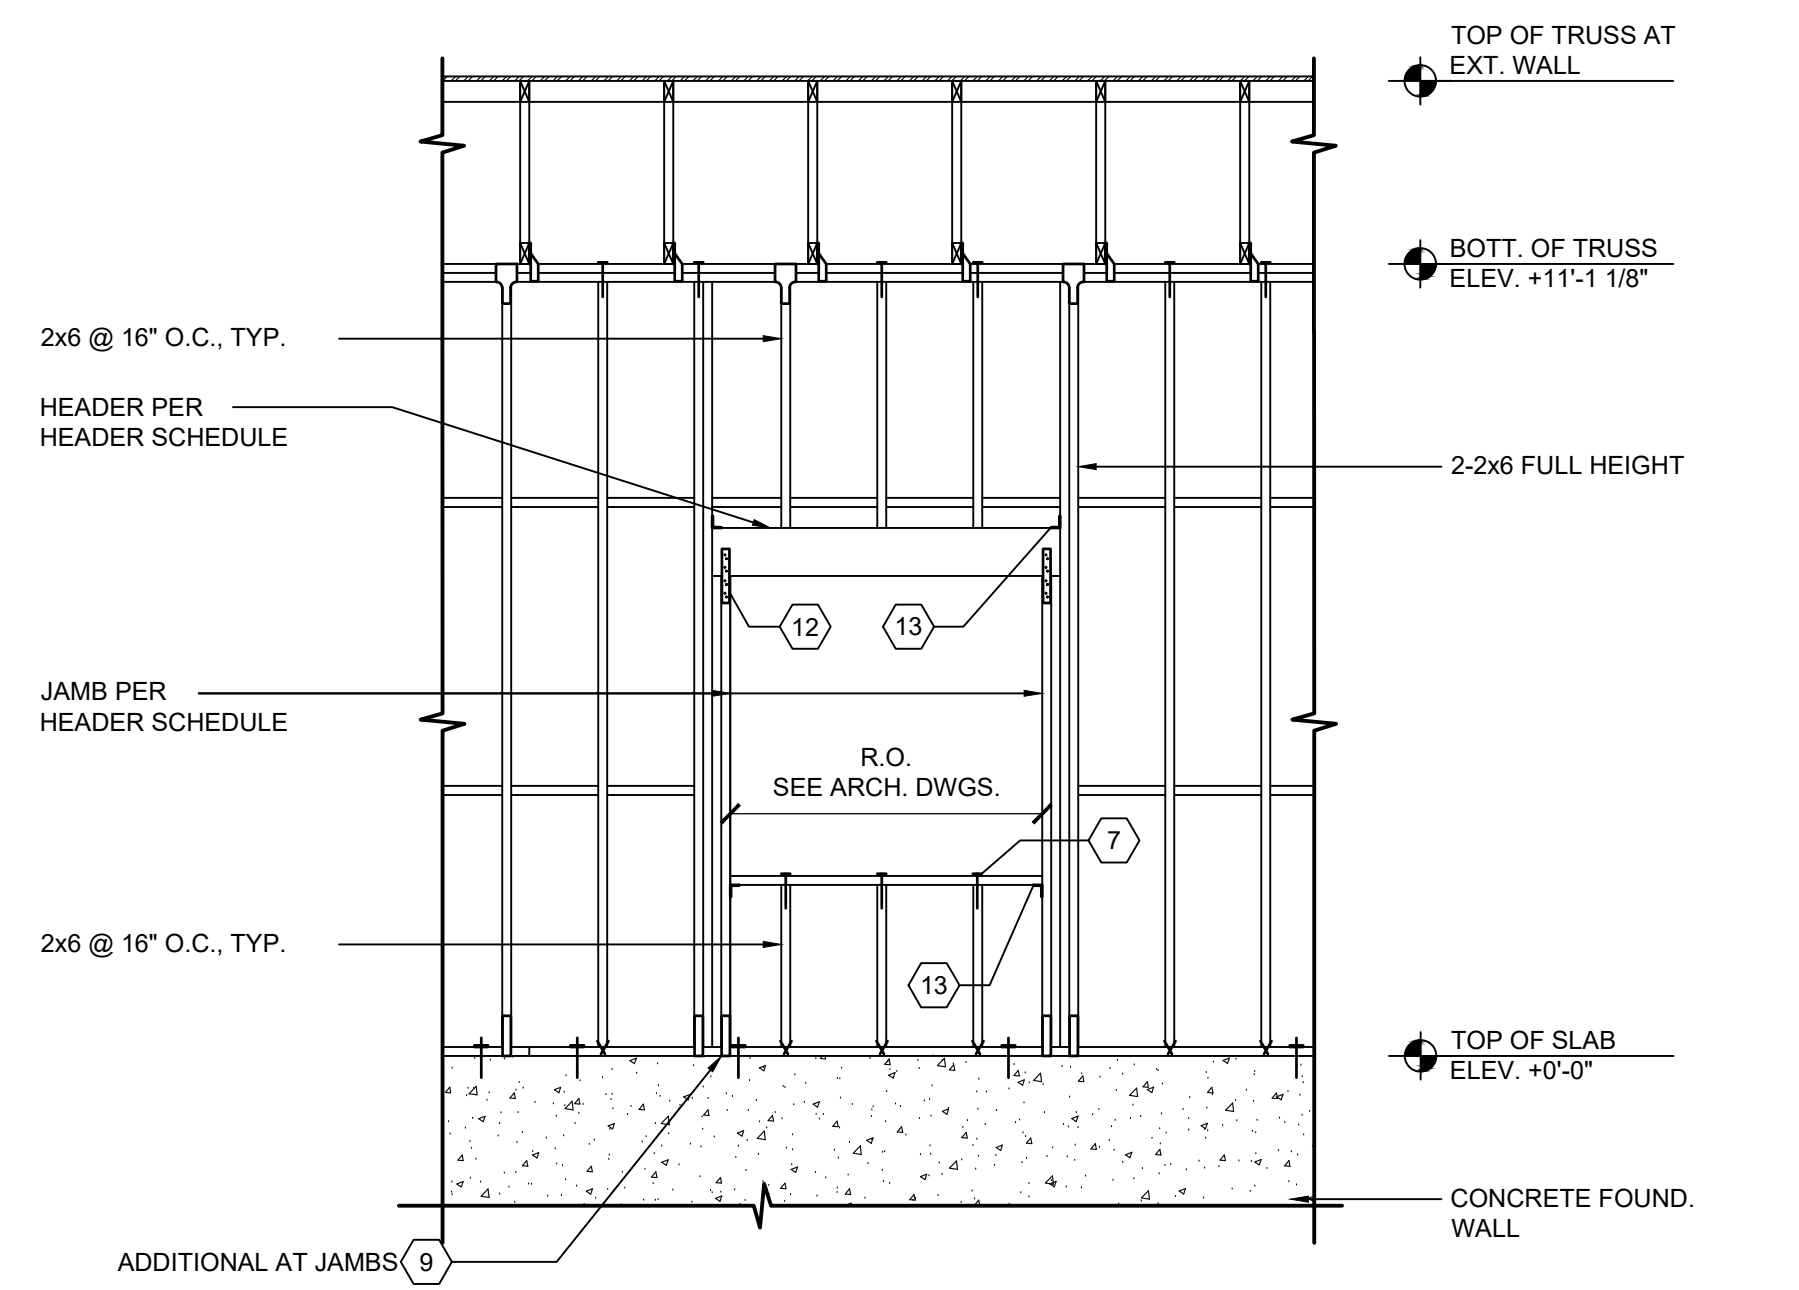

2 TYPICAL BEARING WALL OPENING ELEVATION
SCALE : 3/8" = 1'-0"

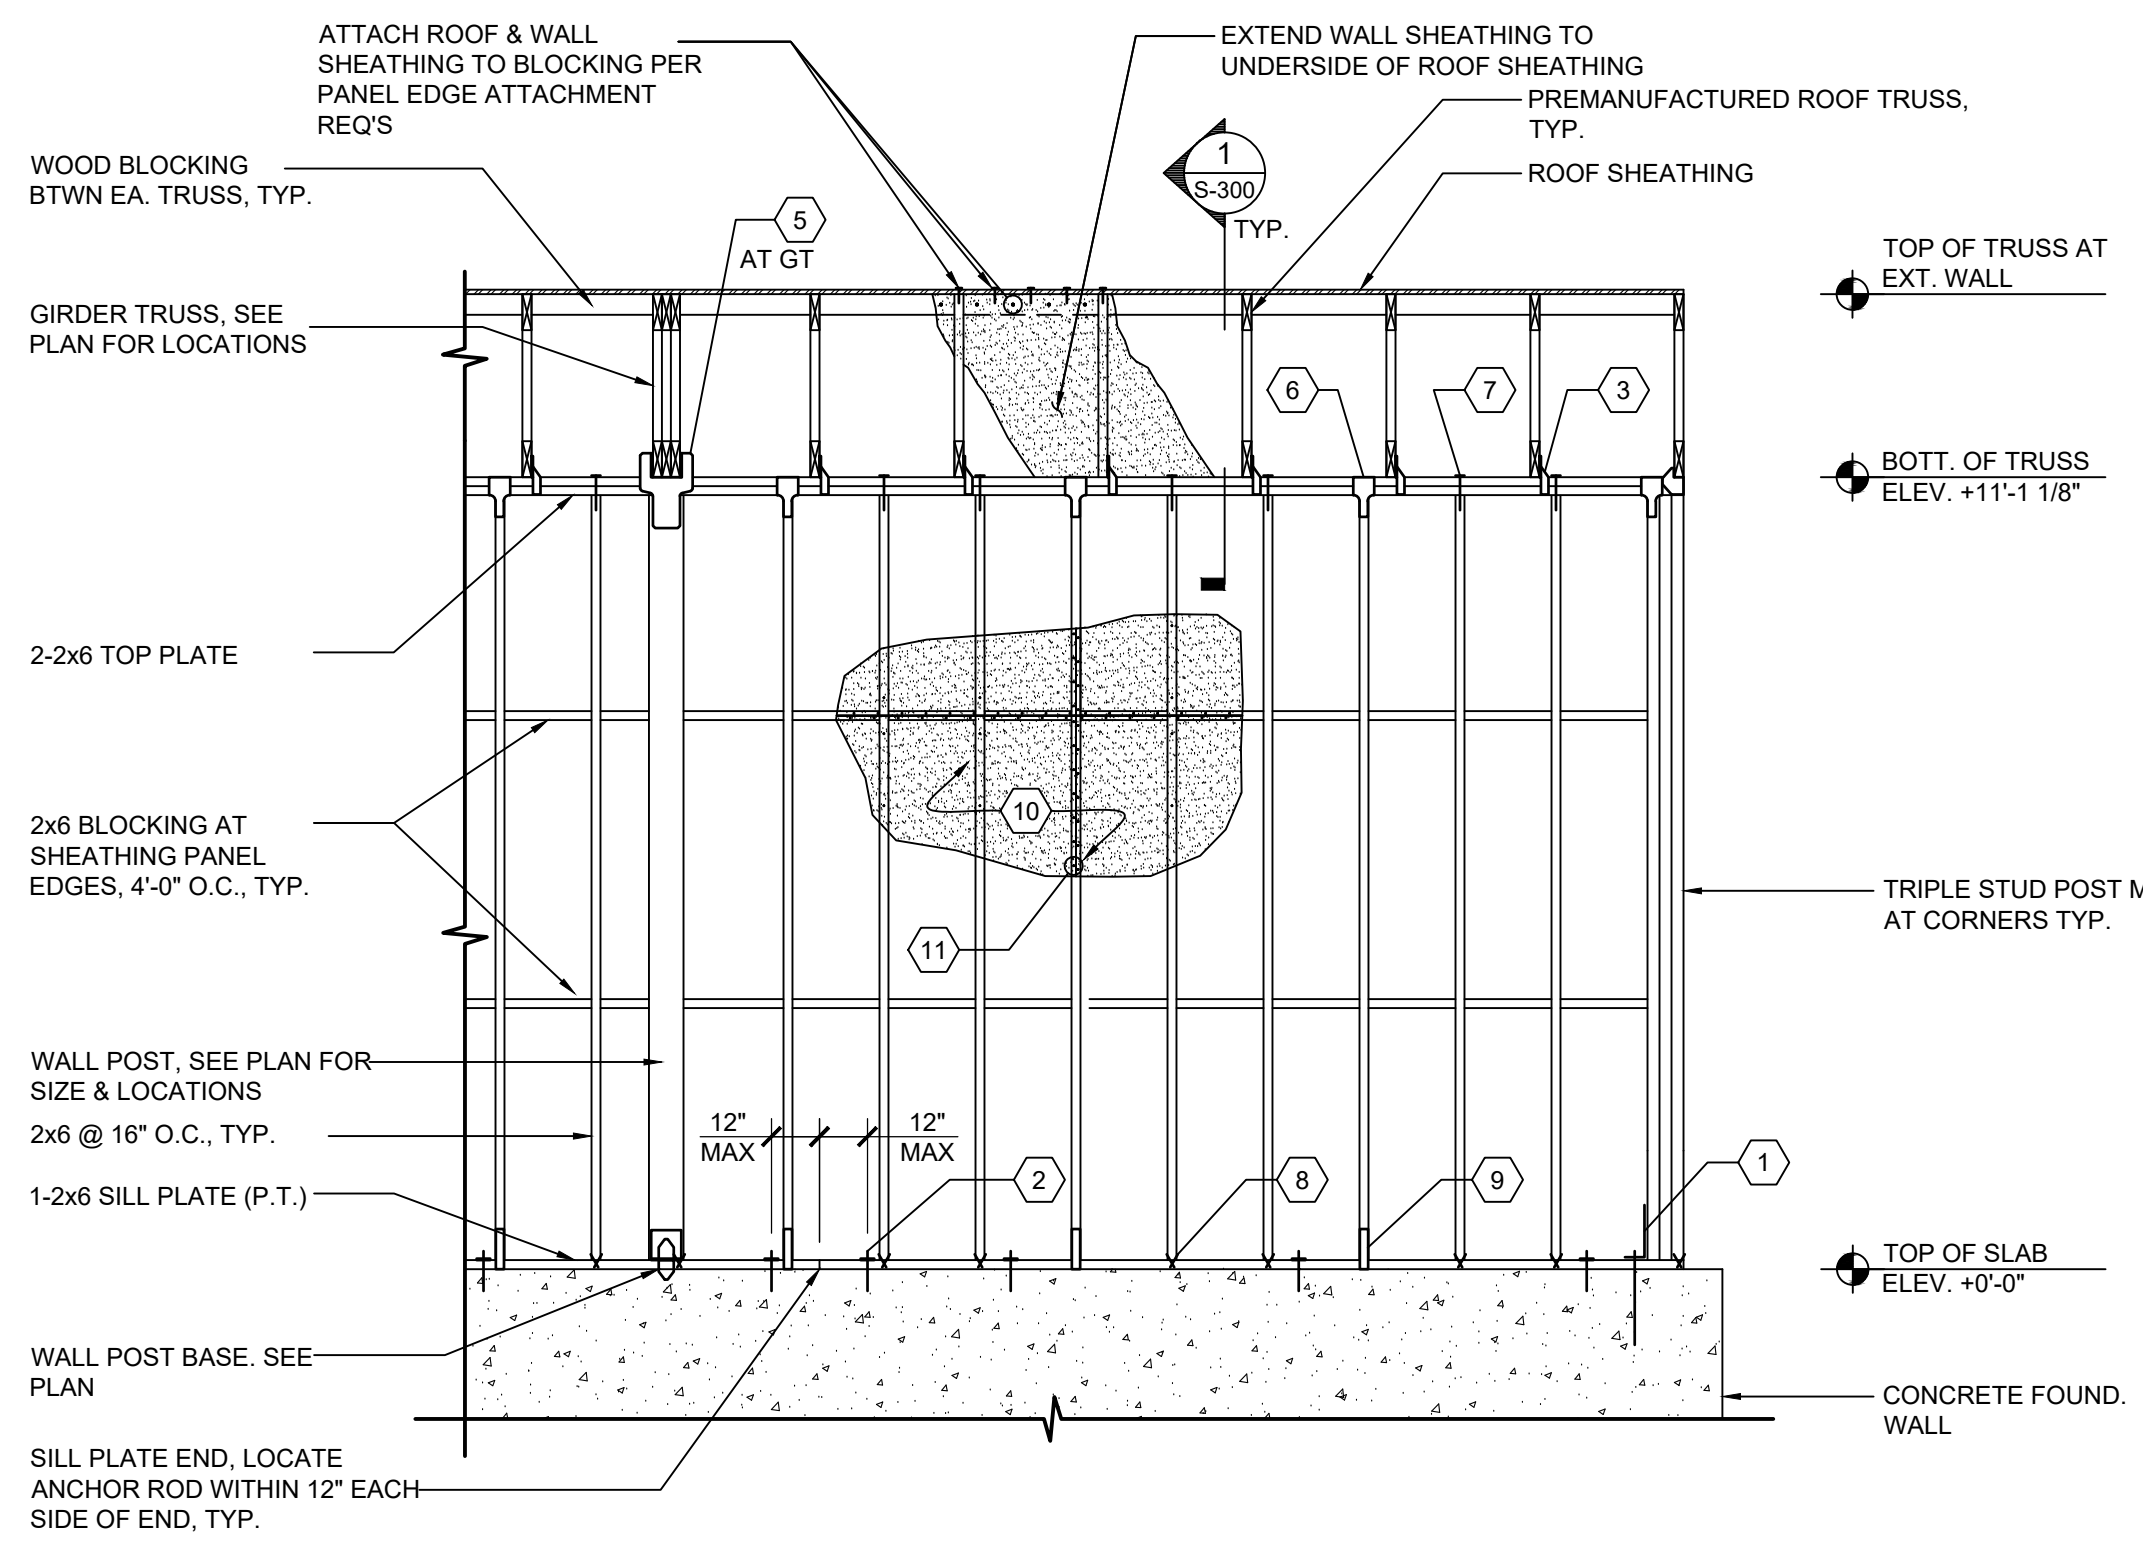

1 TYPICAL EXTERIOR SHEAR BEARING WALL ELEVATION
SCALE : 3/8" = 1'-0"
NOTE: HARDWARE LOCATIONS SHOWN ARE DIAGRAMATIC ONLY. SEE SHEAR WALL ELEVATION SCHEDULE FOR LOCATIONS AND SPACING

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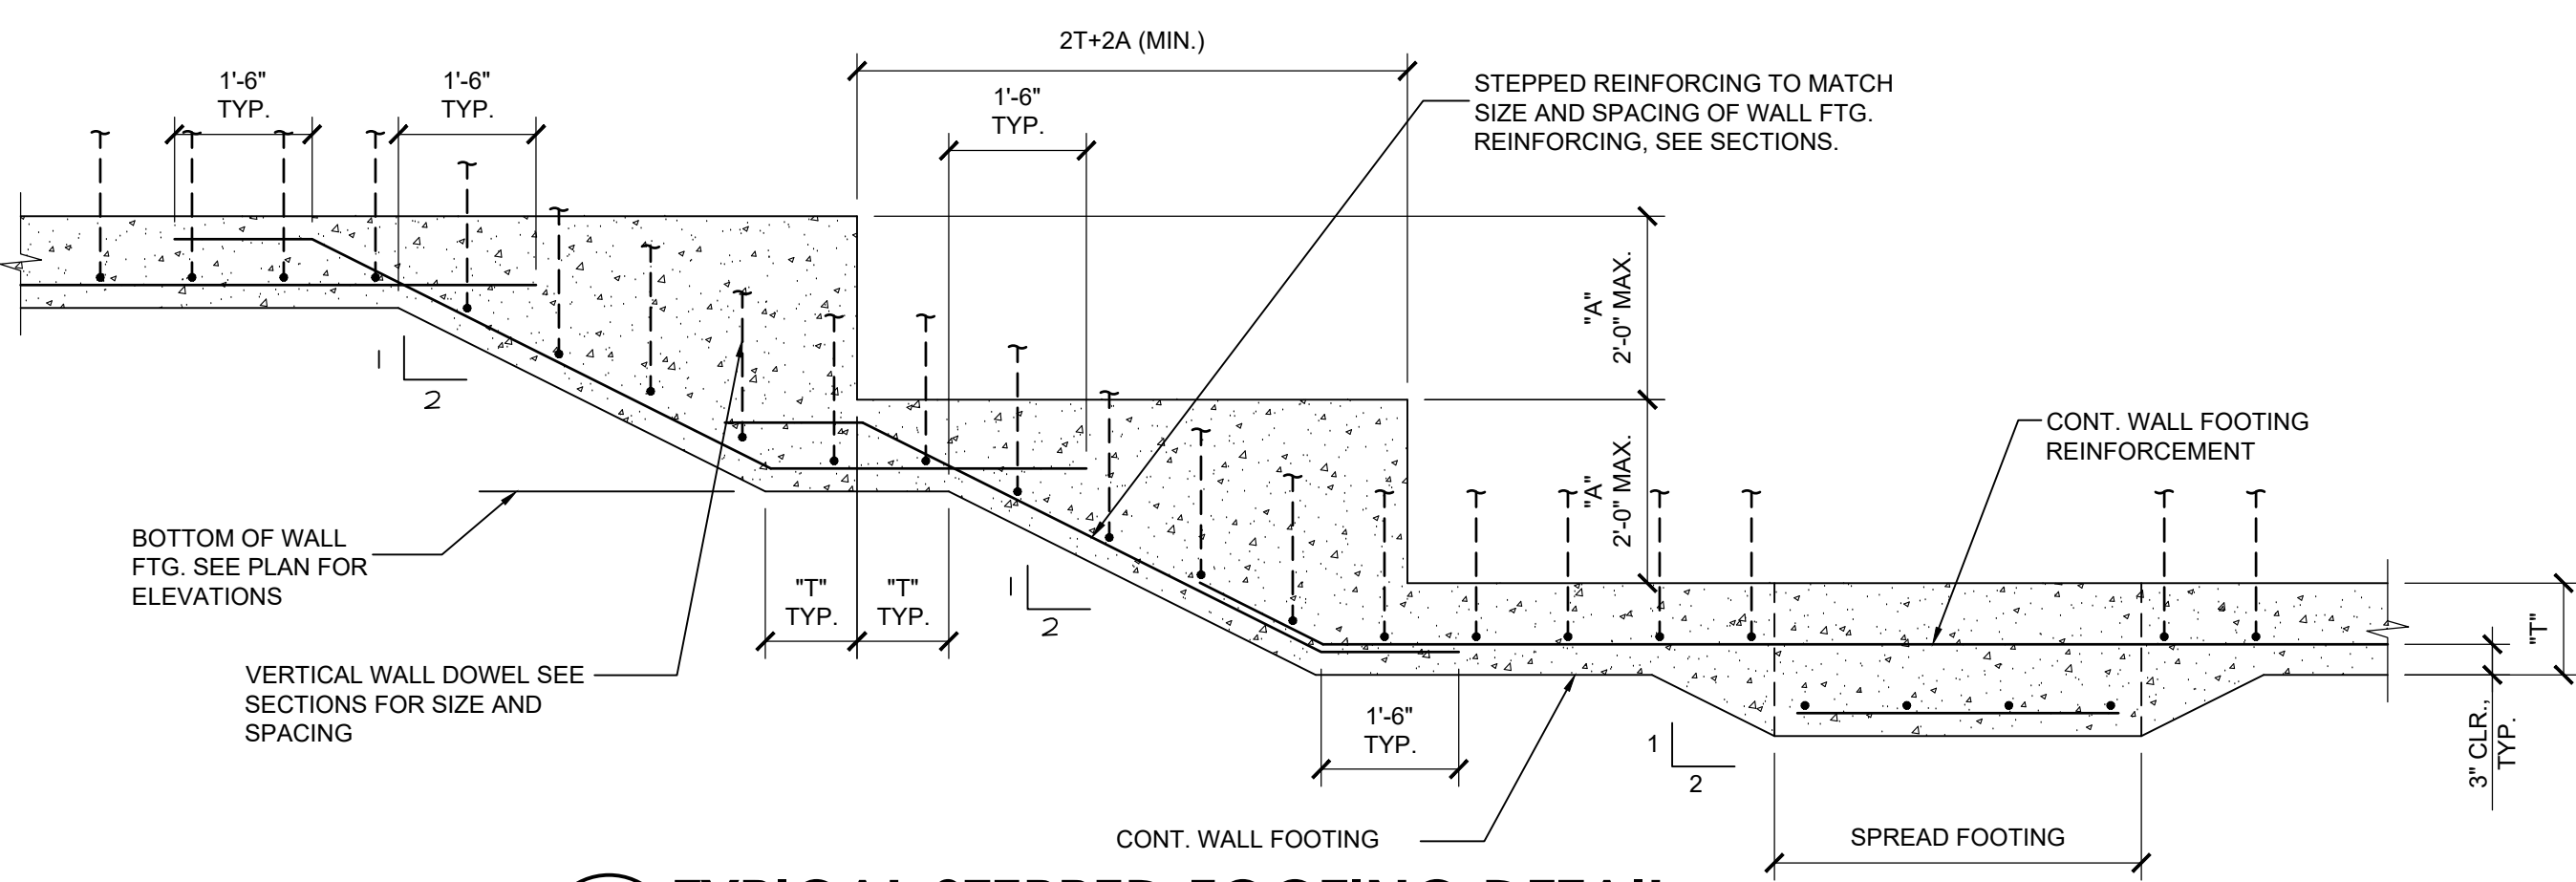
REVISION			
NO.	DATE	DESCRIPTION	INT.

PROFESSIONAL CERTIFICATION
NAME OF LICENSEE: SHANNON CROWNOVER
LICENSE NUMBER: 0402 06 6228

Project Number: TLEVA23-034 Scale: AS NOTED
Drawn By: R.E. Approved By: SC


Drawing Name: **WALL ELEVATIONS**
Drawing Number: **S-103**
SHANNON NICOLE CROWNOVER
Lic. No. 0412066228
PROFESSIONAL ENGINEER

DRAWINGS TITLE: THE LEARNING EXPERIENCE I.T.E. VIRGINIA TLEVA23-034 - TLE WINCHESTERVA 2600 PLEASANT VALLEY WAY CDIST ILEVA23-034-S-200-FOUNDATION SECTIONS DWG. REINFORCING PLOTTED: 12/19/2023




11 TYPICAL STEPPED FOOTING DETAIL
SCALE: 1/2" = 1'-0"


FOOTINGS FOR THIS PROJECT ARE NOT SHOWN ON PLAN TO BE STEPPED. THIS DETAIL IS ONLY TO BE USED SHOULD SITE CONDITIONS REQUIRE LOWERING/RAISING OF A PORTION OF THE FOOTING CREATING THE STEPPED FOOTING CONDITION.

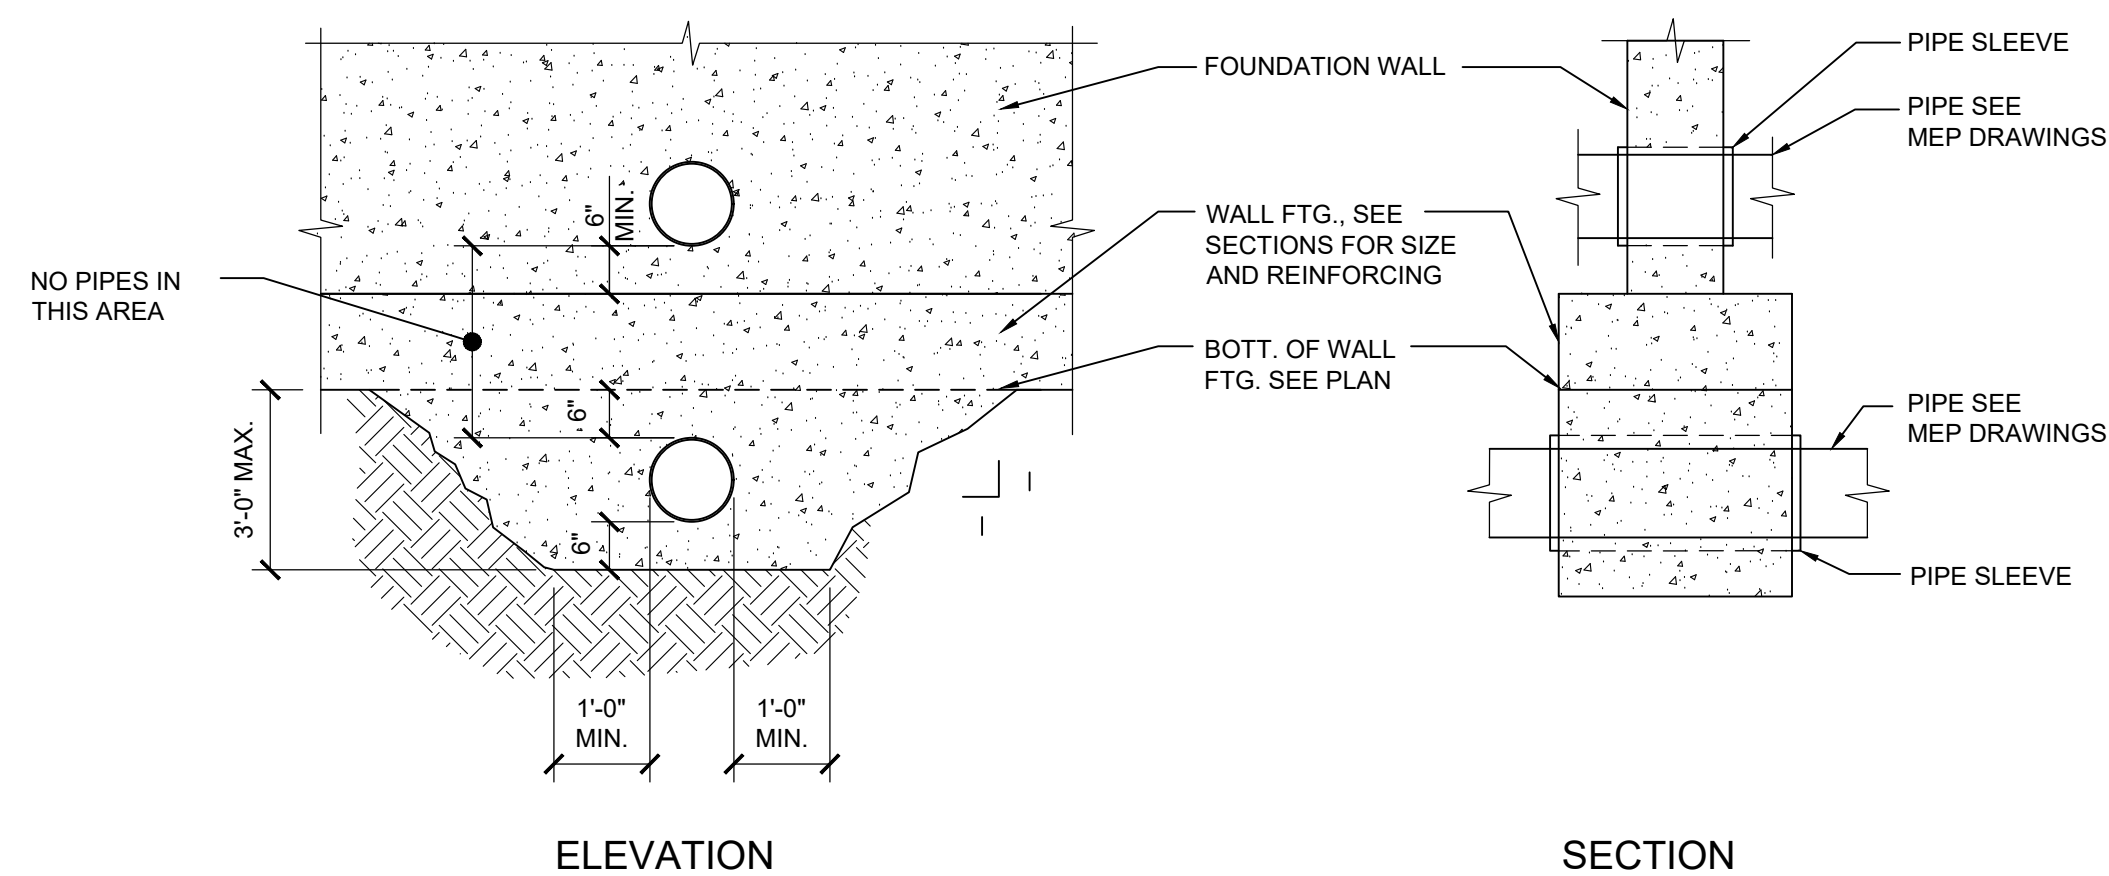

10 TYPICAL PIPE AT FOUNDATION WALL
SCALE: 1/2" = 1'-0"

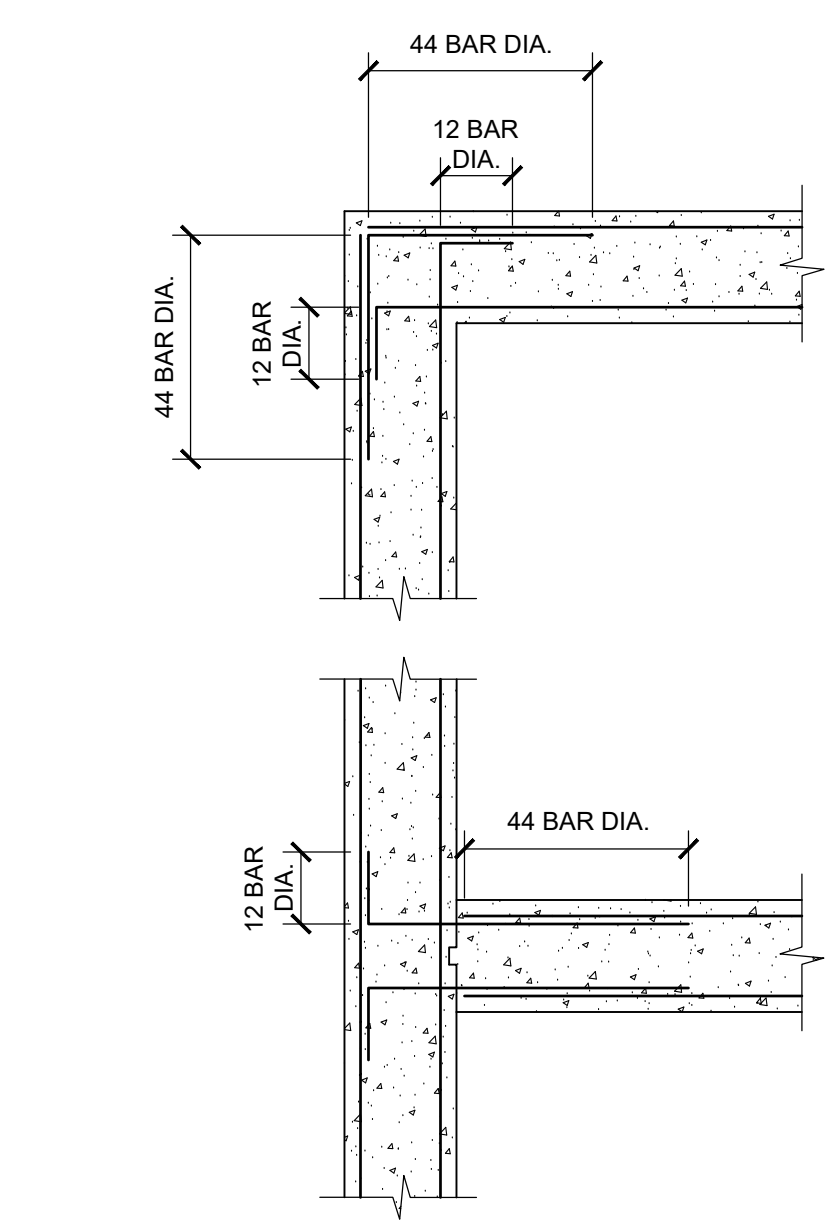


9 TYPICAL WALL INTERSECTION/CORNER REINFORCING DETAIL
SCALE: 1/2" = 1'-0"

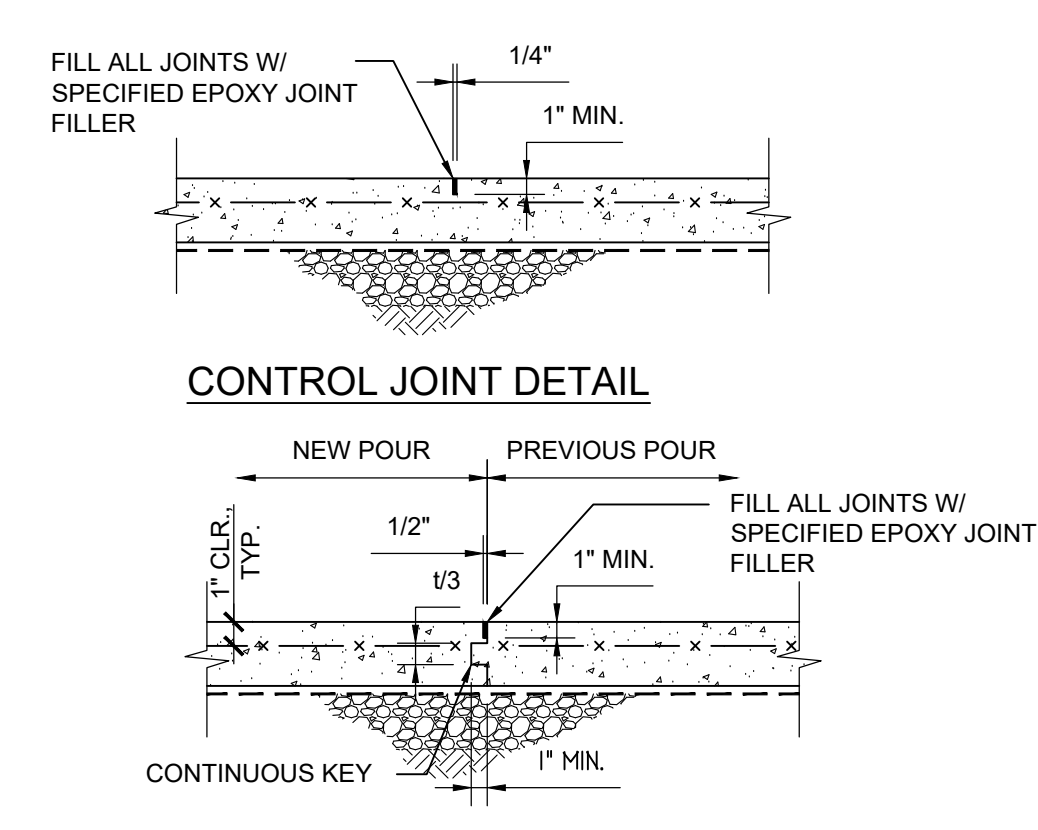


8 TYPICAL CONTROL JOINT DETAIL
SCALE: N.T.S.


- NOTES:
- CONTROL JOINTS SHALL BE LOCATED BY THE CONTRACTOR AT THE SPACING REQUIRED TO MEET SPECIFIED CRITERIA FOR MAXIMUM SLAB ON GRADE AREA BETWEEN CONTROL JOINTS.
 - LOCATE CONSTRUCTION JOINTS AT CONTROL JOINT LOCATIONS.
 - LOCATE JOINTS AS SHOWN ON THE DRAWINGS. MAXIMUM SPACING OF CONTROL JOINTS SHALL NOT EXCEED 20'-0" IN ANY DIRECTION.
 - SAW CUT JOINTS IMMEDIATELY AFTER SLAB RECEIVES FINAL STEEL TROWEL. ALL CUTTING RESIDUE SHALL BE REMOVED IMMEDIATELY FROM TOP OF CONCRETE SLAB.

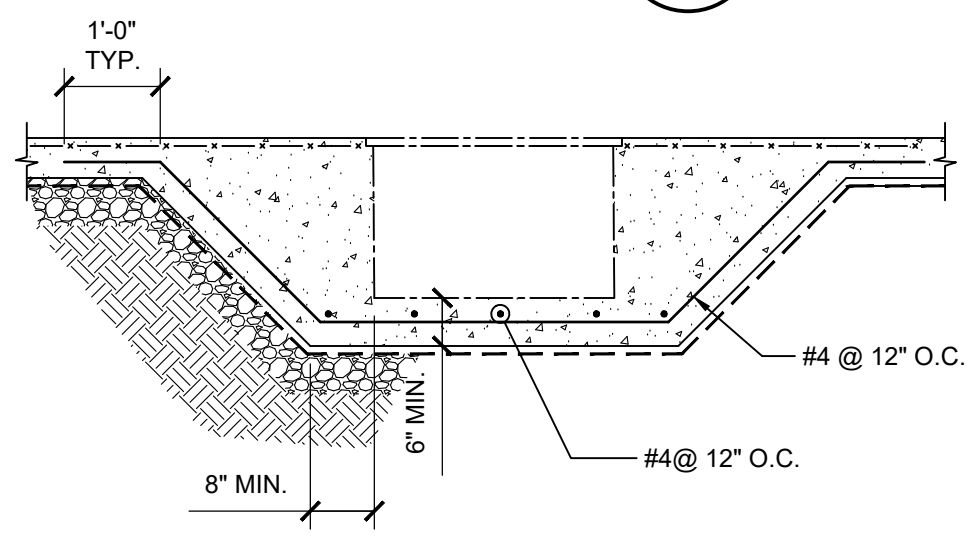


6 TYPICAL GREASE TRAP DETAIL
SCALE: 1/2" = 1'-0"

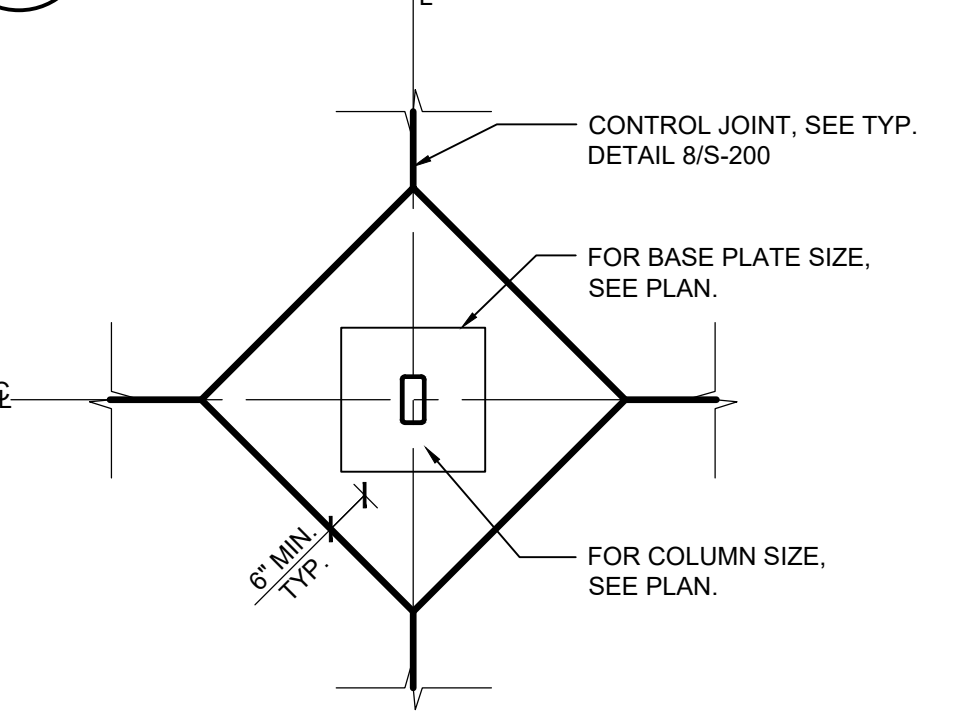


7 TYPICAL CONTROL JOINT DETAIL AT COLUMN
SCALE: 1/2" = 1'-0"

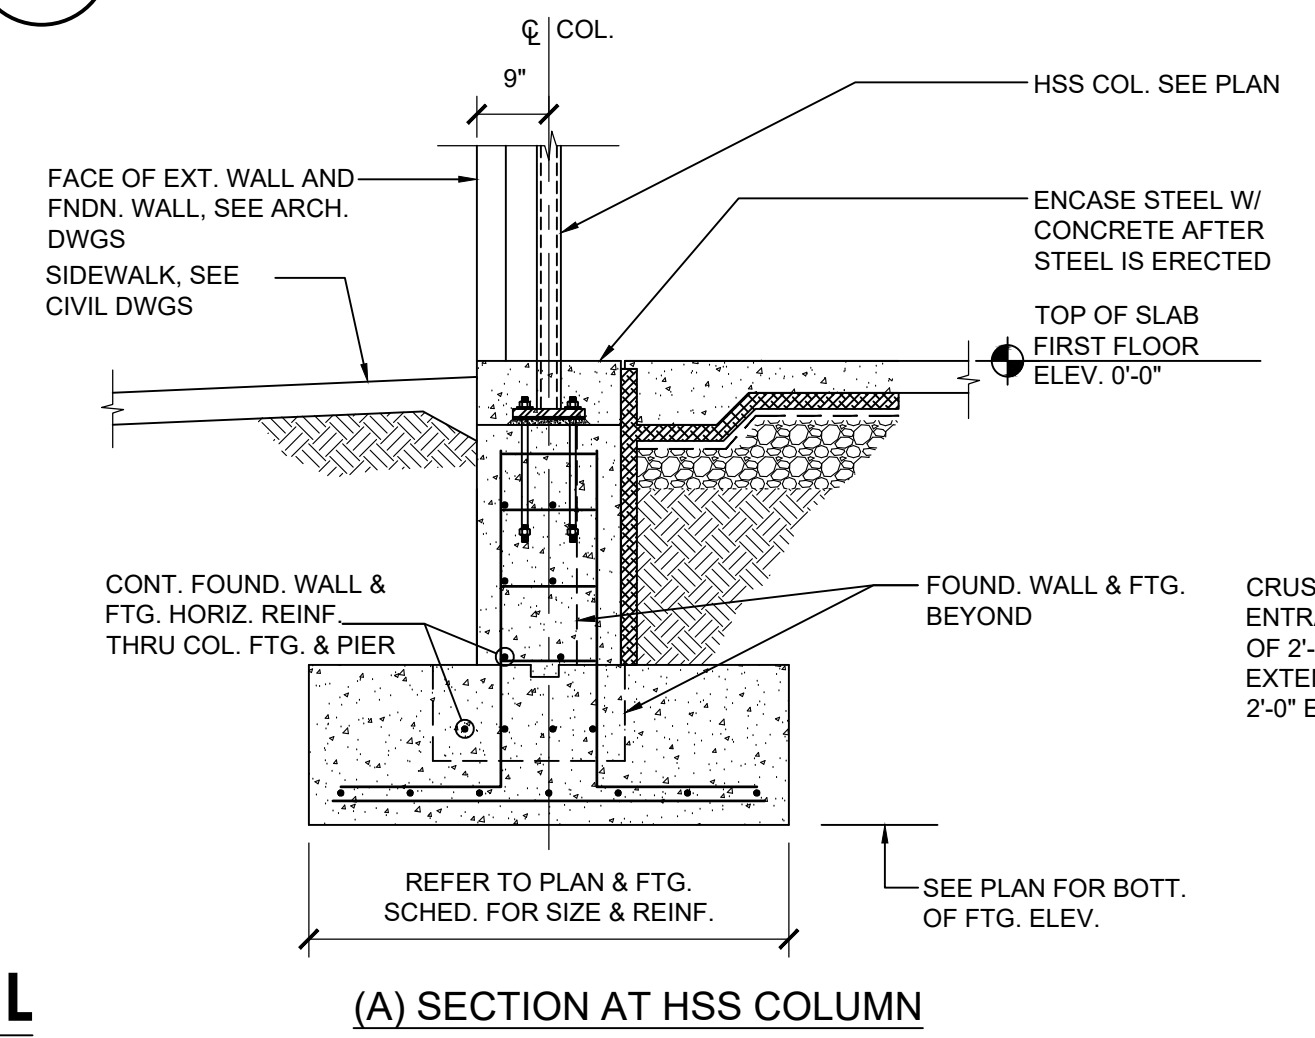


5 TYPICAL PIPE PENETRATION THRU CONC. FNDN WALL
SCALE: 1/2" = 1'-0"

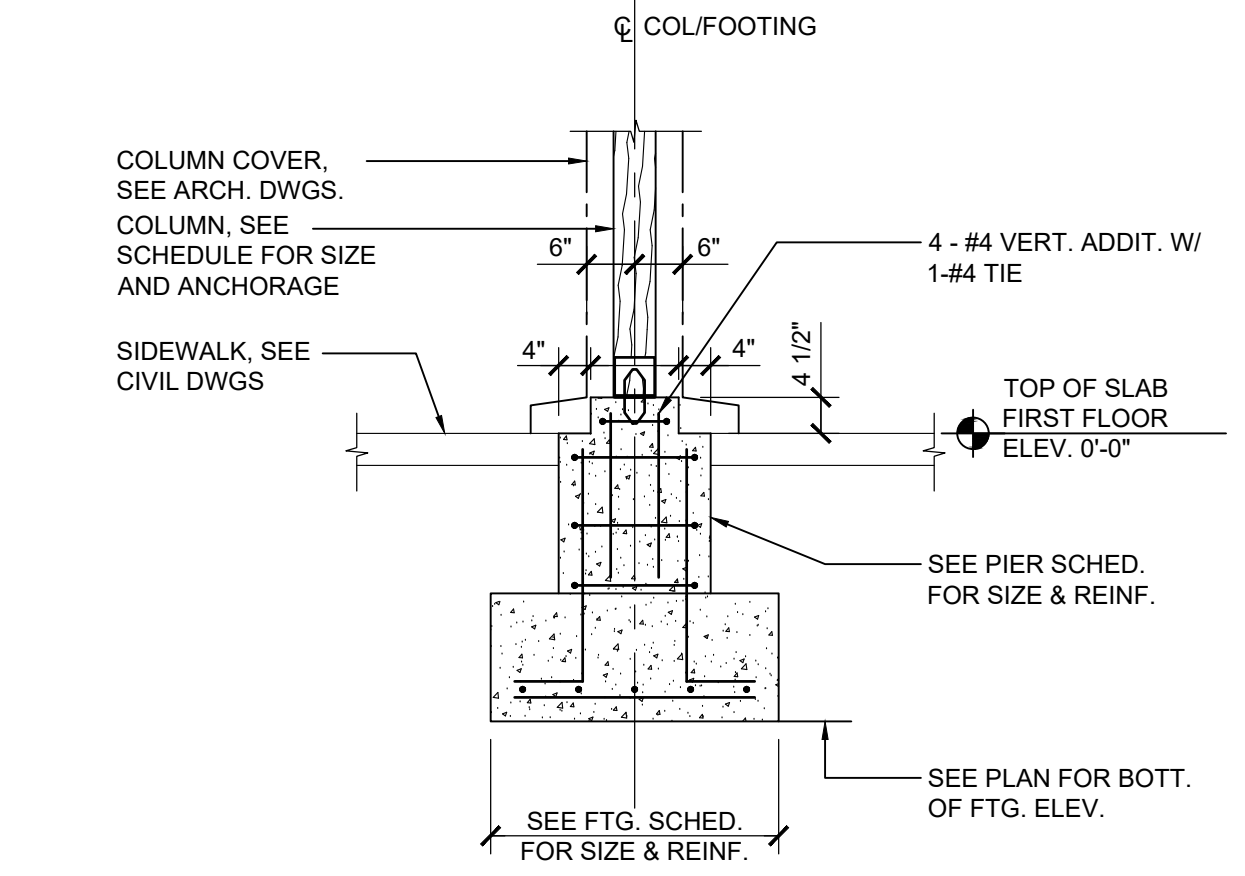

4 CANOPY COLUMN FOOTING DETAIL
SCALE: 1/2" = 1'-0"

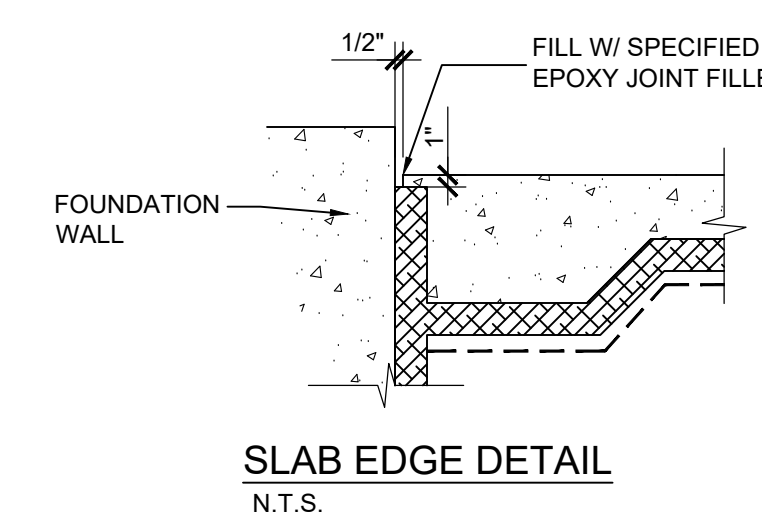


3 TYPICAL INTERIOR COLUMN FOOTING WITH PIER DETAIL
SCALE: 1/2" = 1'-0"

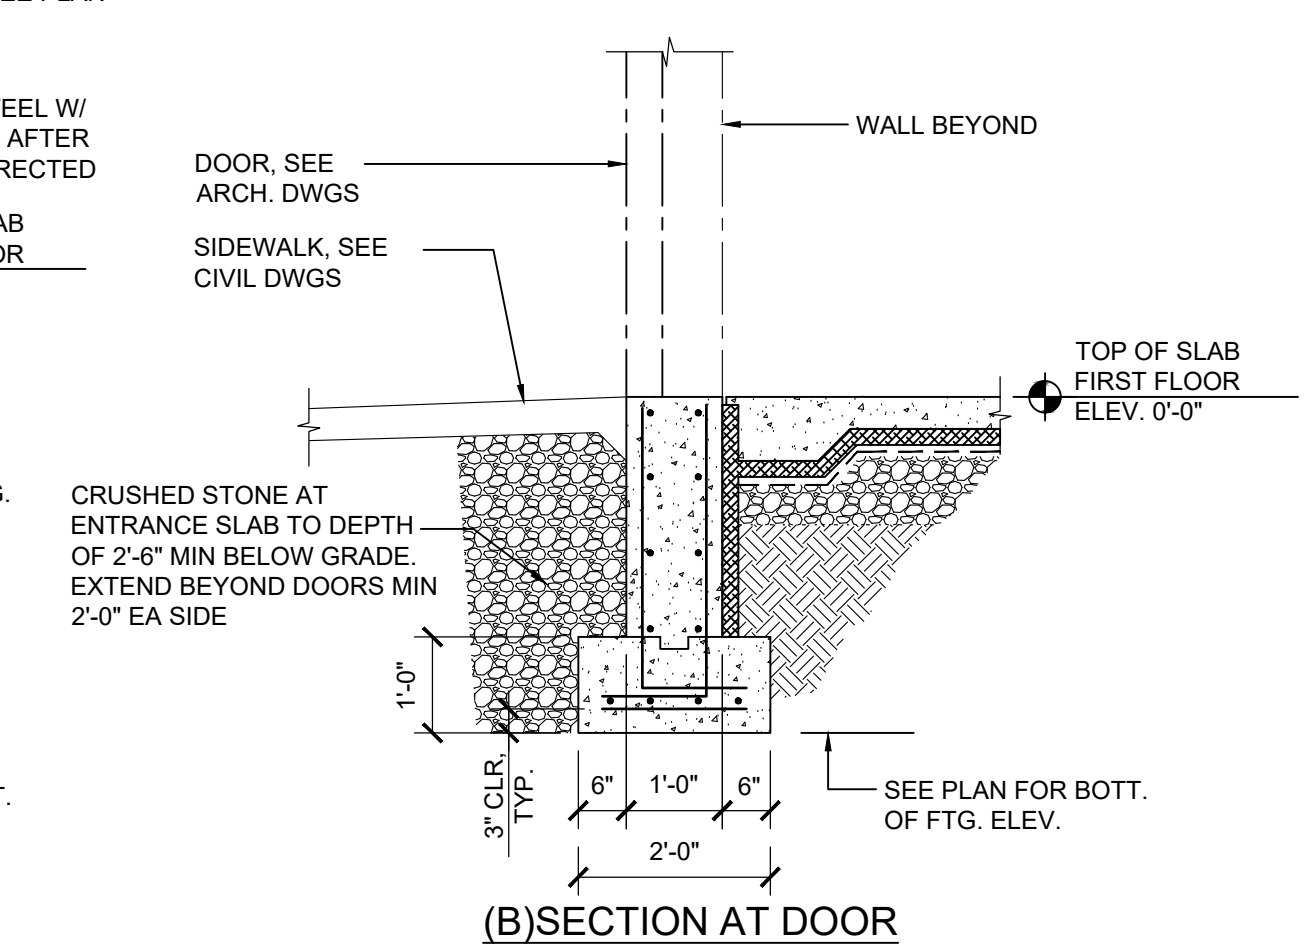

2 TYPICAL INTERIOR COLUMN FOOTING DETAIL
SCALE: 1/2" = 1'-0"

1 EXTERIOR WALL DETAIL
SCALE: 1/2" = 1'-0"

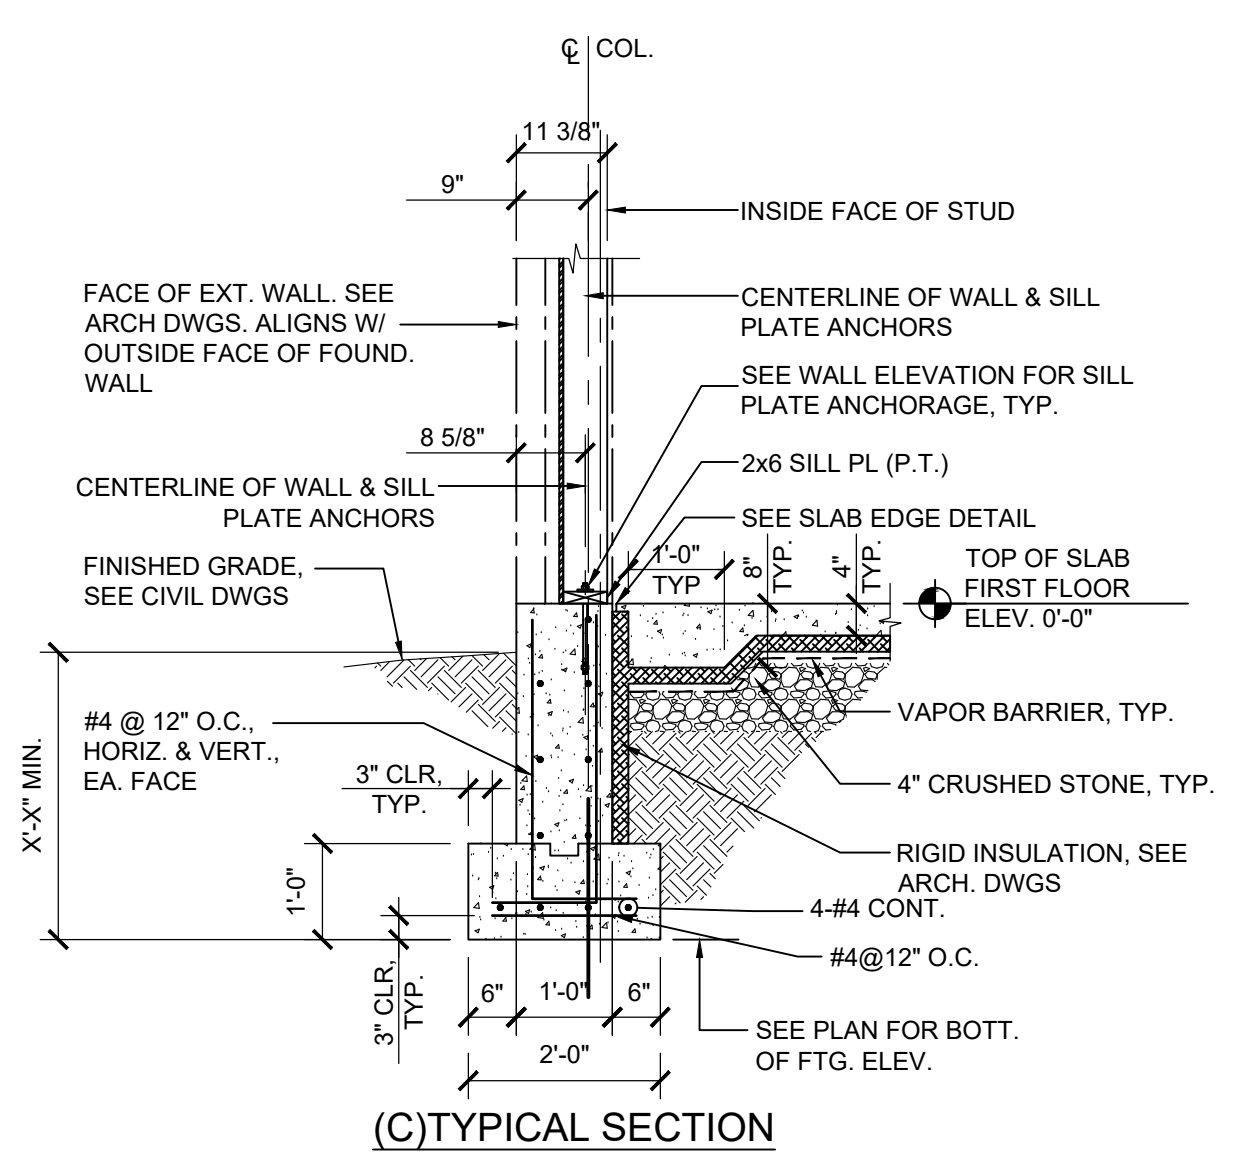

- CONTRACTOR SHALL SUPERVISE AND DIRECT THE WORK USING THE CONTRACTOR'S BEST SKILL AND ATTENTION. THE CONTRACTOR SHALL BE SOLELY RESPONSIBLE AND HAVE CONTROL OVER CONSTRUCTION MEANS, METHODS, TECHNIQUES, SEQUENCE, AND JOB SITE SAFETY.
- GC MUST PROVIDE & INSTALL ALL PRODUCTS PER PLANS. ONLY SUBSTITUTED PRODUCTS NEED TO BE SUBMITTED TO THE ARCHITECT FOR APPROVAL. UNAPPROVED SUBSTITUTIONS WILL BE REPLACED AT THE EXPENSE OF THE GC.
- VERBAL REPRESENTATION HAS NO VALUE AND ALL REQUESTS TO CHANGE ANY PRODUCTS OR SPECIFICATIONS PER PLANS, MUST BE SUBMITTED IN WRITING TO THE ARCHITECT & TLE FOR APPROVAL.

Jarmel Kizel
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42 OKNER PARKWAY
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Architecture
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THE LEARNING EXPERIENCE
ACADEMY OF EARLY EDUCATION
2600 PLEASANT VALLEY ROAD
WINCHESTER, VIRGINIA 22601

ISSUE			
NO.	DATE	DESCRIPTION	INT.
1	09-29-23	FOR TLE REVIEW	MBJ
2	12-19-23	FOR PERMIT	MBJ
REVISION			
NO.	DATE	DESCRIPTION	INT.

PROFESSIONAL CERTIFICATION
NAME OF LICENSEE: SHANNON CROWNOVER
LICENSE NUMBER: 0402 06 6228

Project Number: TLEVA23-034 Scale: AS NOTED
Drawn By: R.E. Approved By: SC

Drawing Name: FOUNDATION SECTIONS

Drawing Number: **S-200**
SHANNON NICOLE CROWNOVER
Lic. No. 0402066228
PROFESSIONAL ENGINEER

H:\DRAWINGS\TILE - THE LEARNING EXPERIENCE\TILE - VIRGINIA\TILEVA23-034 - TLE WINCHESTERVA 2600 PLEASANT VALLEY WAY\CD\STILEVA23-034-S-300-FRAMING SECTIONS.DWG REI:NAJAJAR PLOTTED: 12/19/2023

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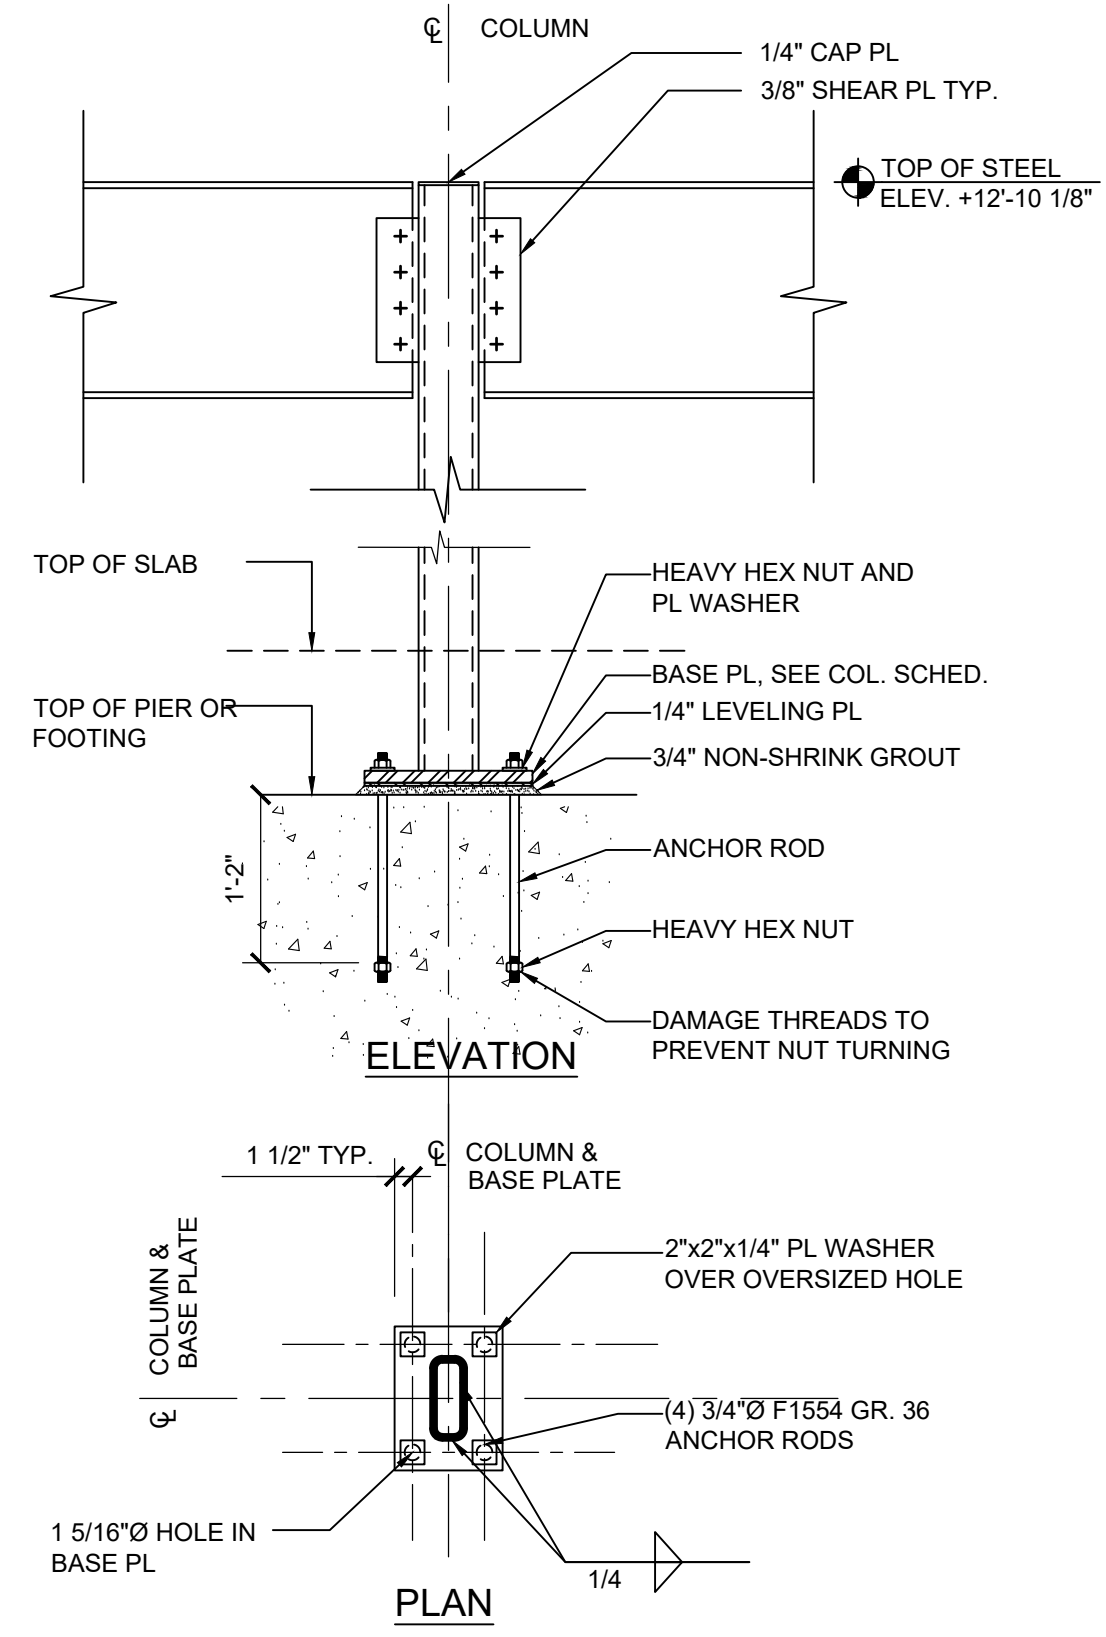
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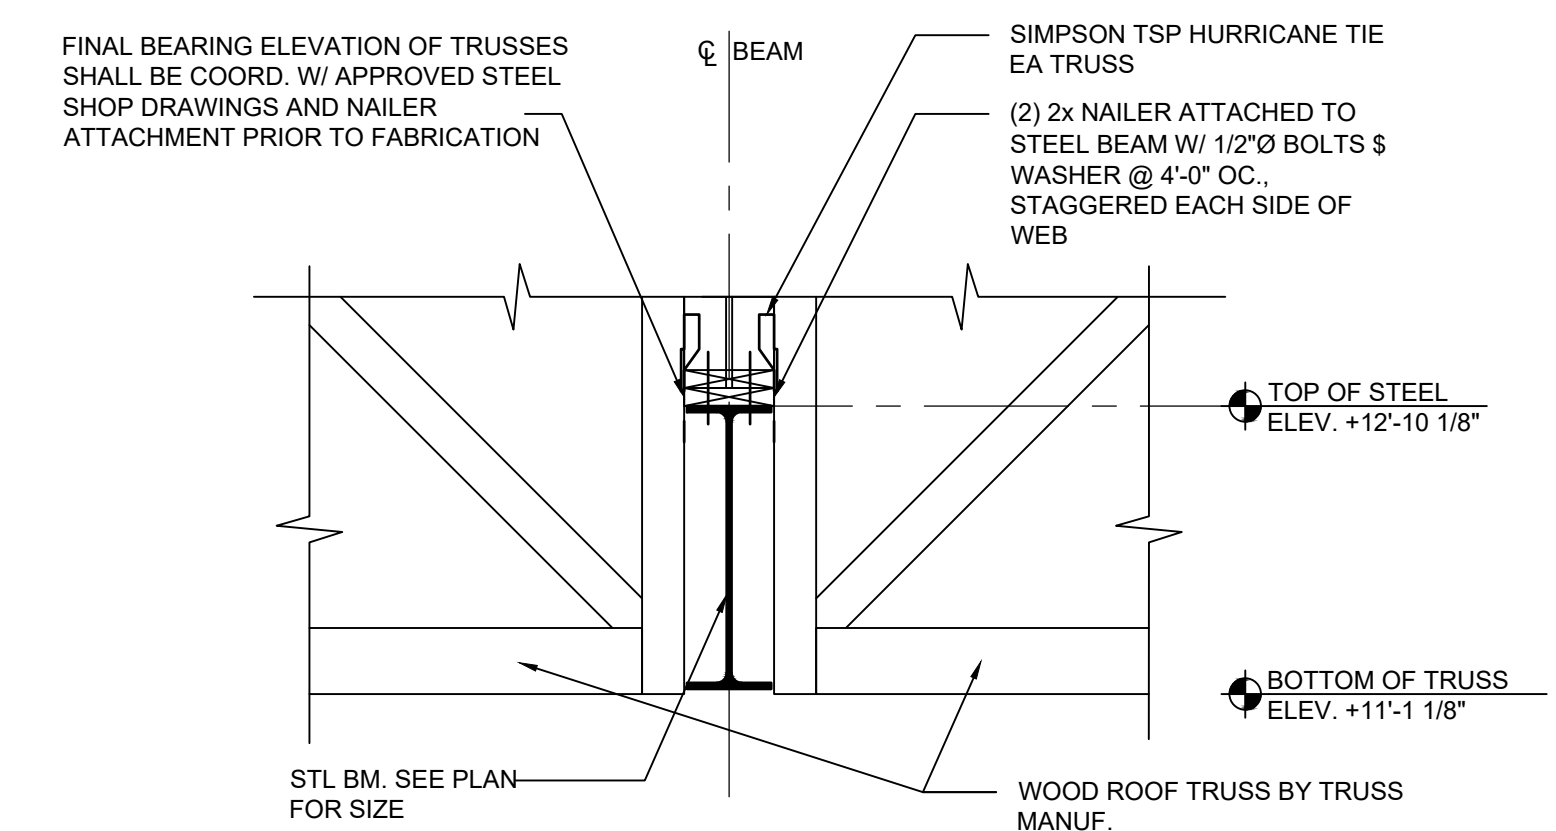
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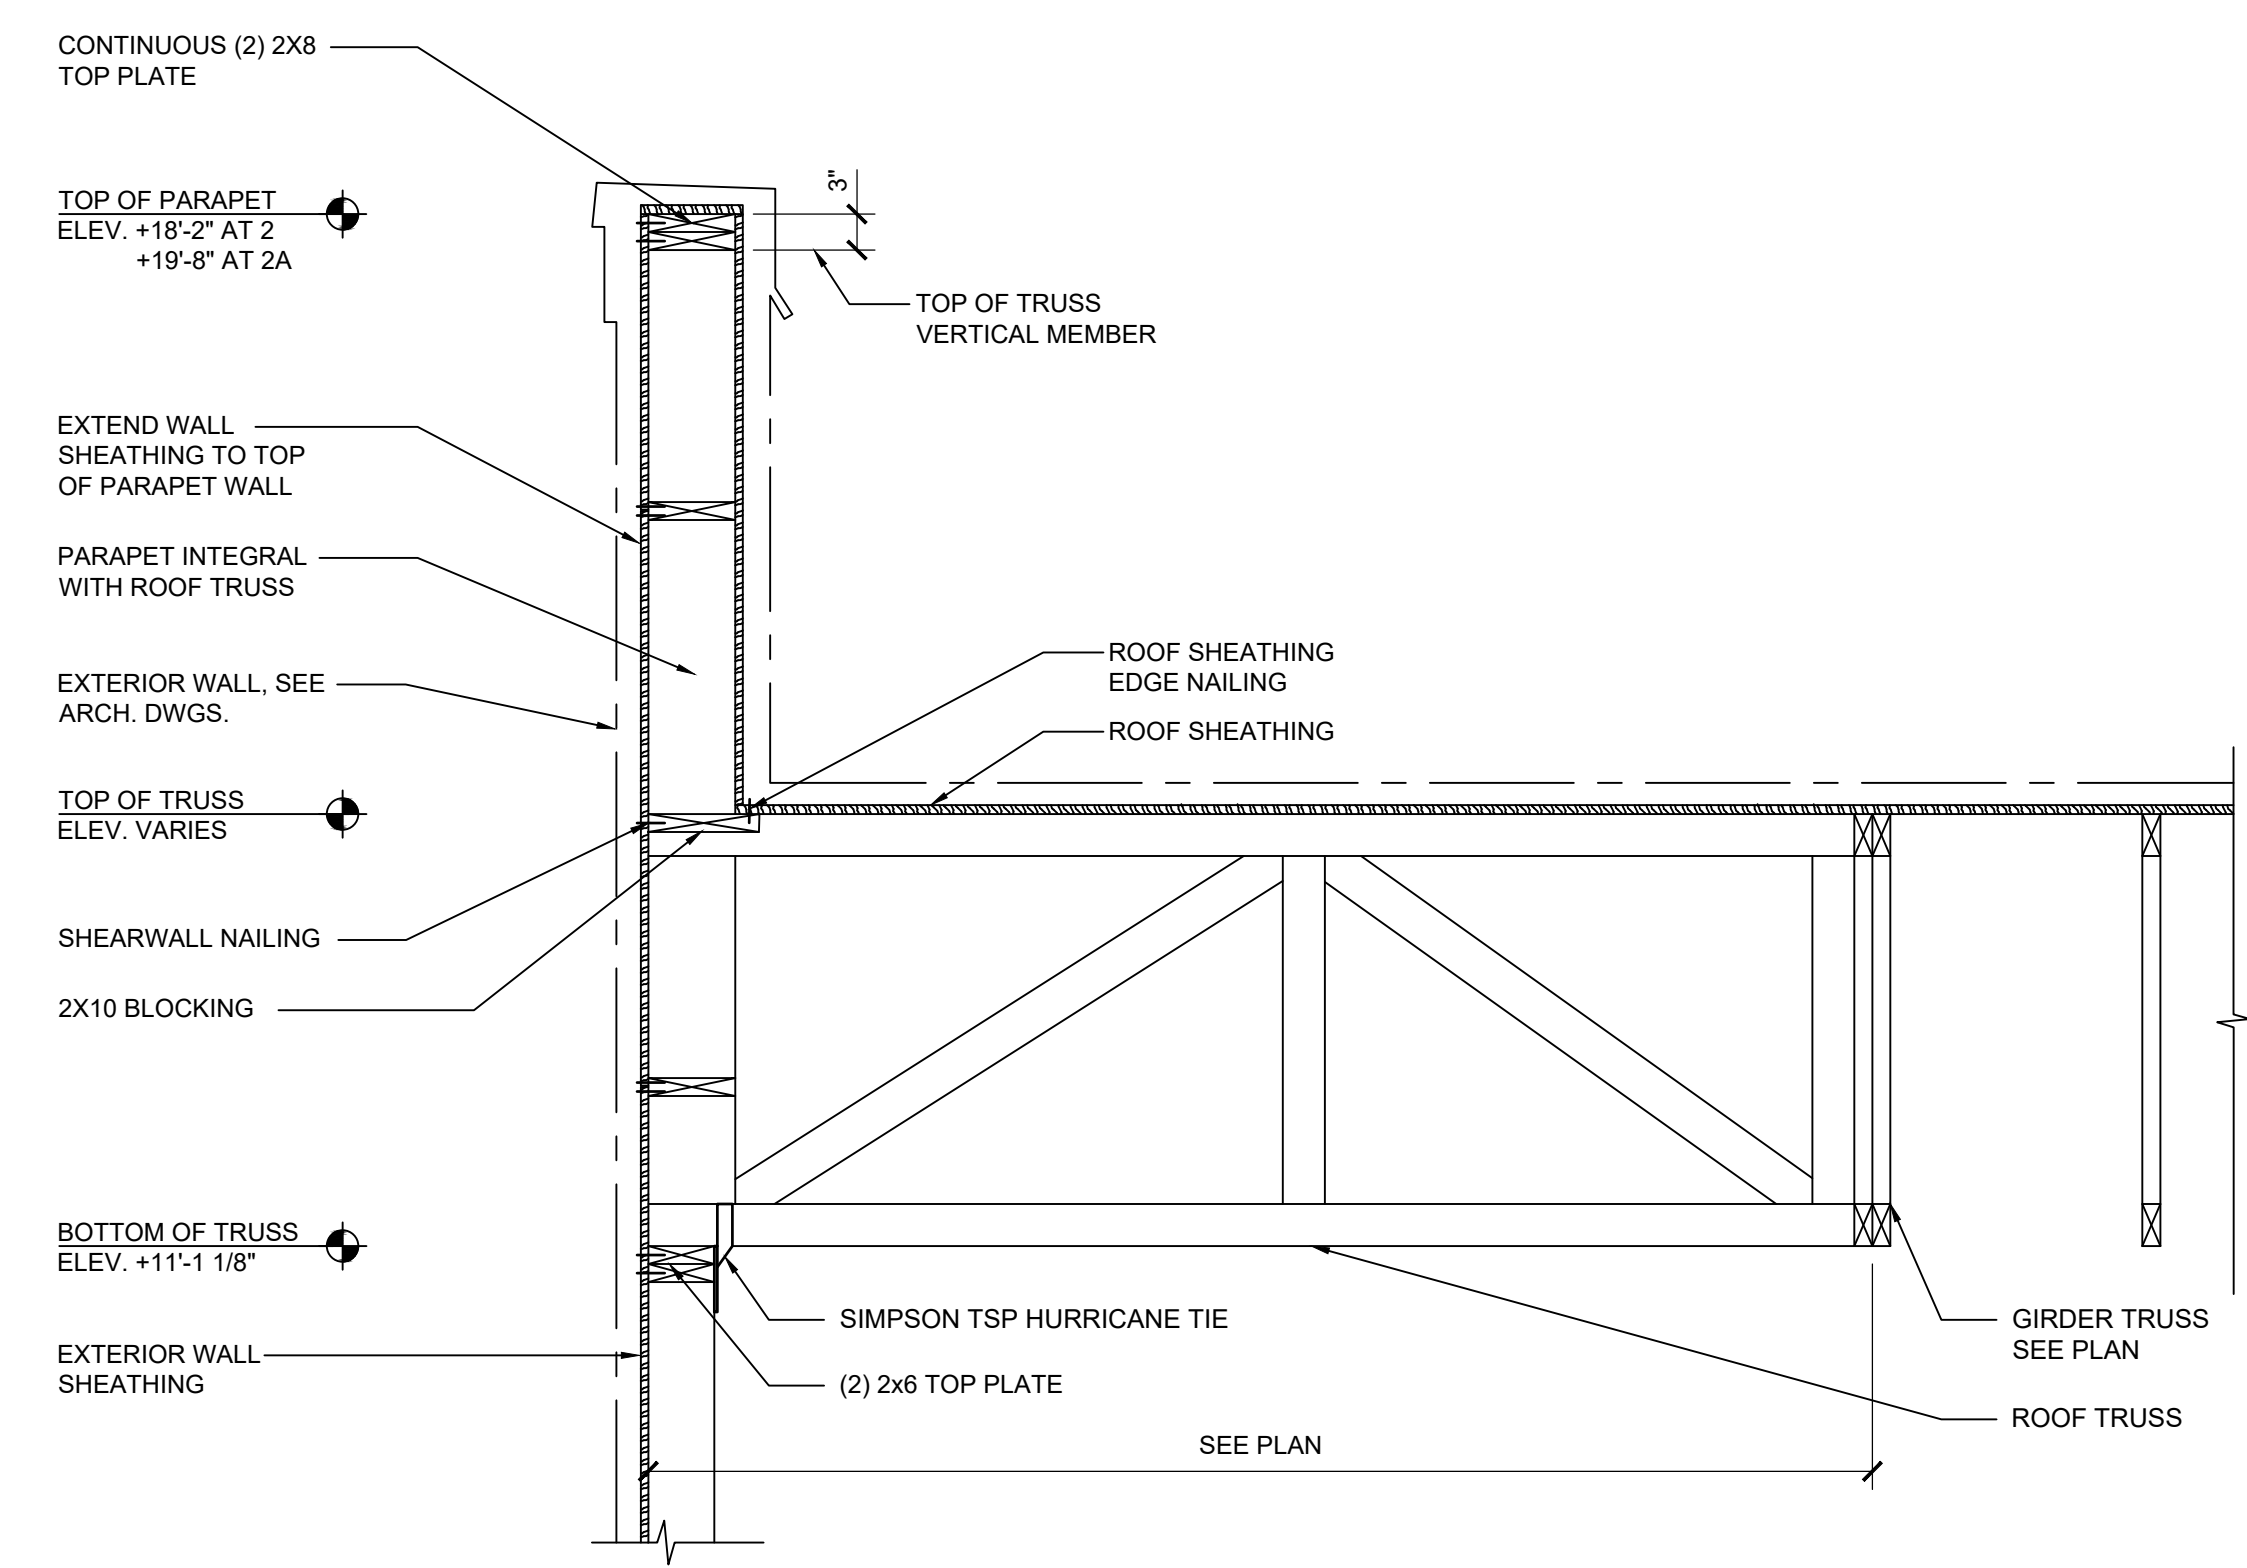
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WINCHESTER, VIRGINIA 22601




4 SECTION AT COLUMN
SCALE : 3/4" = 1'-0"



3 SECTION THRU STEEL BEAM
SCALE : 3/4" = 1'-0"



2 2A SECTION AT EXT. WALL BRG
SCALE : 3/4" = 1'-0"

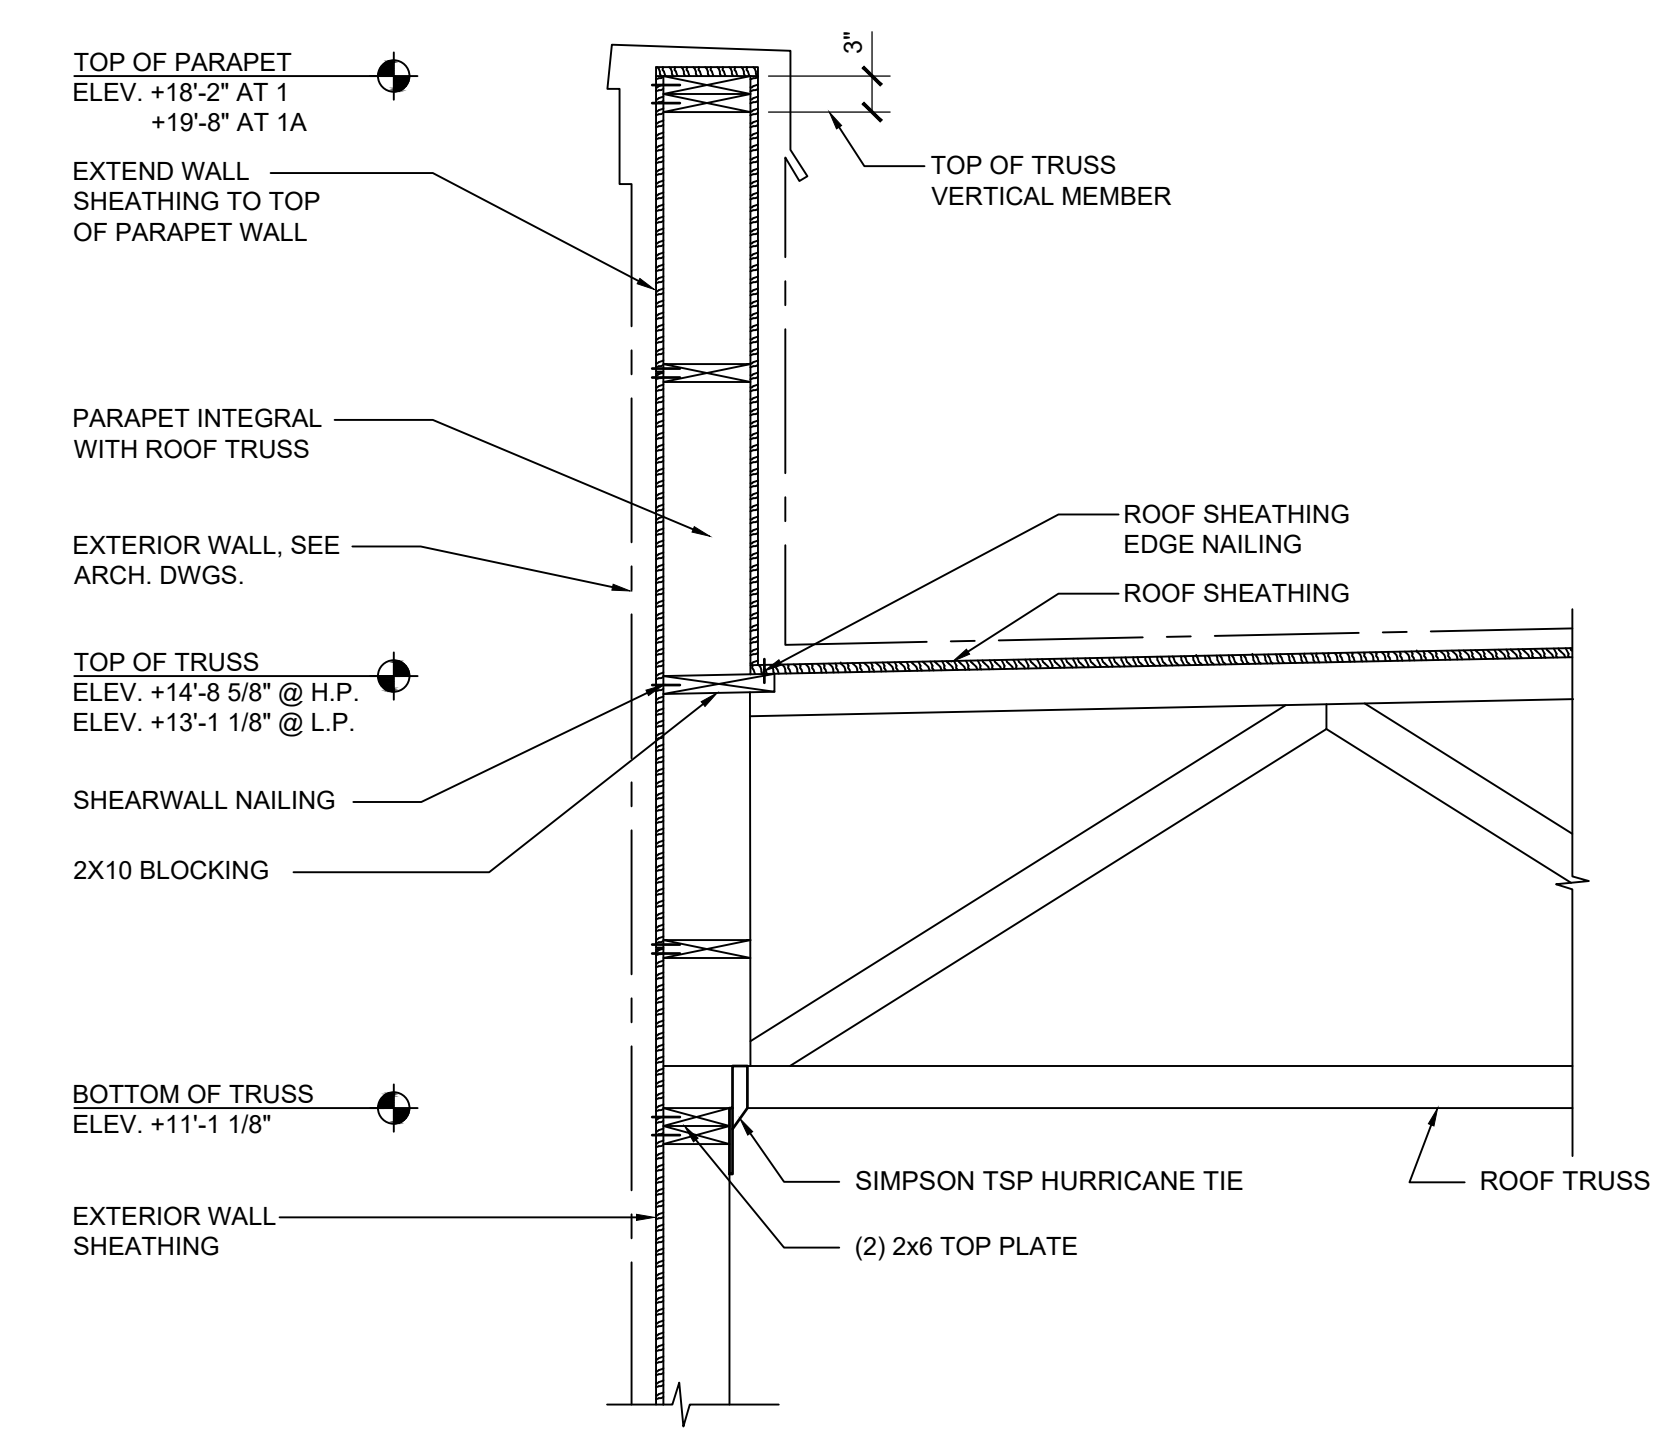

1 SECTION AT EXT. WALL BRG
SCALE : 3/4" = 1'-0"


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PROFESSIONAL CERTIFICATION
NAME OF LICENSEE: SHANNON CROWNOVER
LICENSE NUMBER: 0402 06 6228


Project Number: TLEVA23-034	Scale: AS NOTED
Drawn By: R.E.	Approved By: SC

Drawing Name:
FRAMING SECTIONS


Drawing Number:
S-300

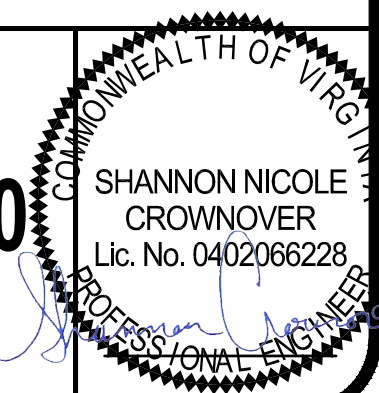

DRAWINGS TITLE: THE LEARNING EXPERIENCE TITLE: WINCHESTERVA 2600 PLEASANT VALLEY WAY CDSTILEVA23-034 - TLE WINCHESTERVA 2600 PLEASANT VALLEY WAY CDSTILEVA23-034-S-301-FRAMING SECTIONS DWG REL: NAJAJAR PLOTTED: 12/19/2023

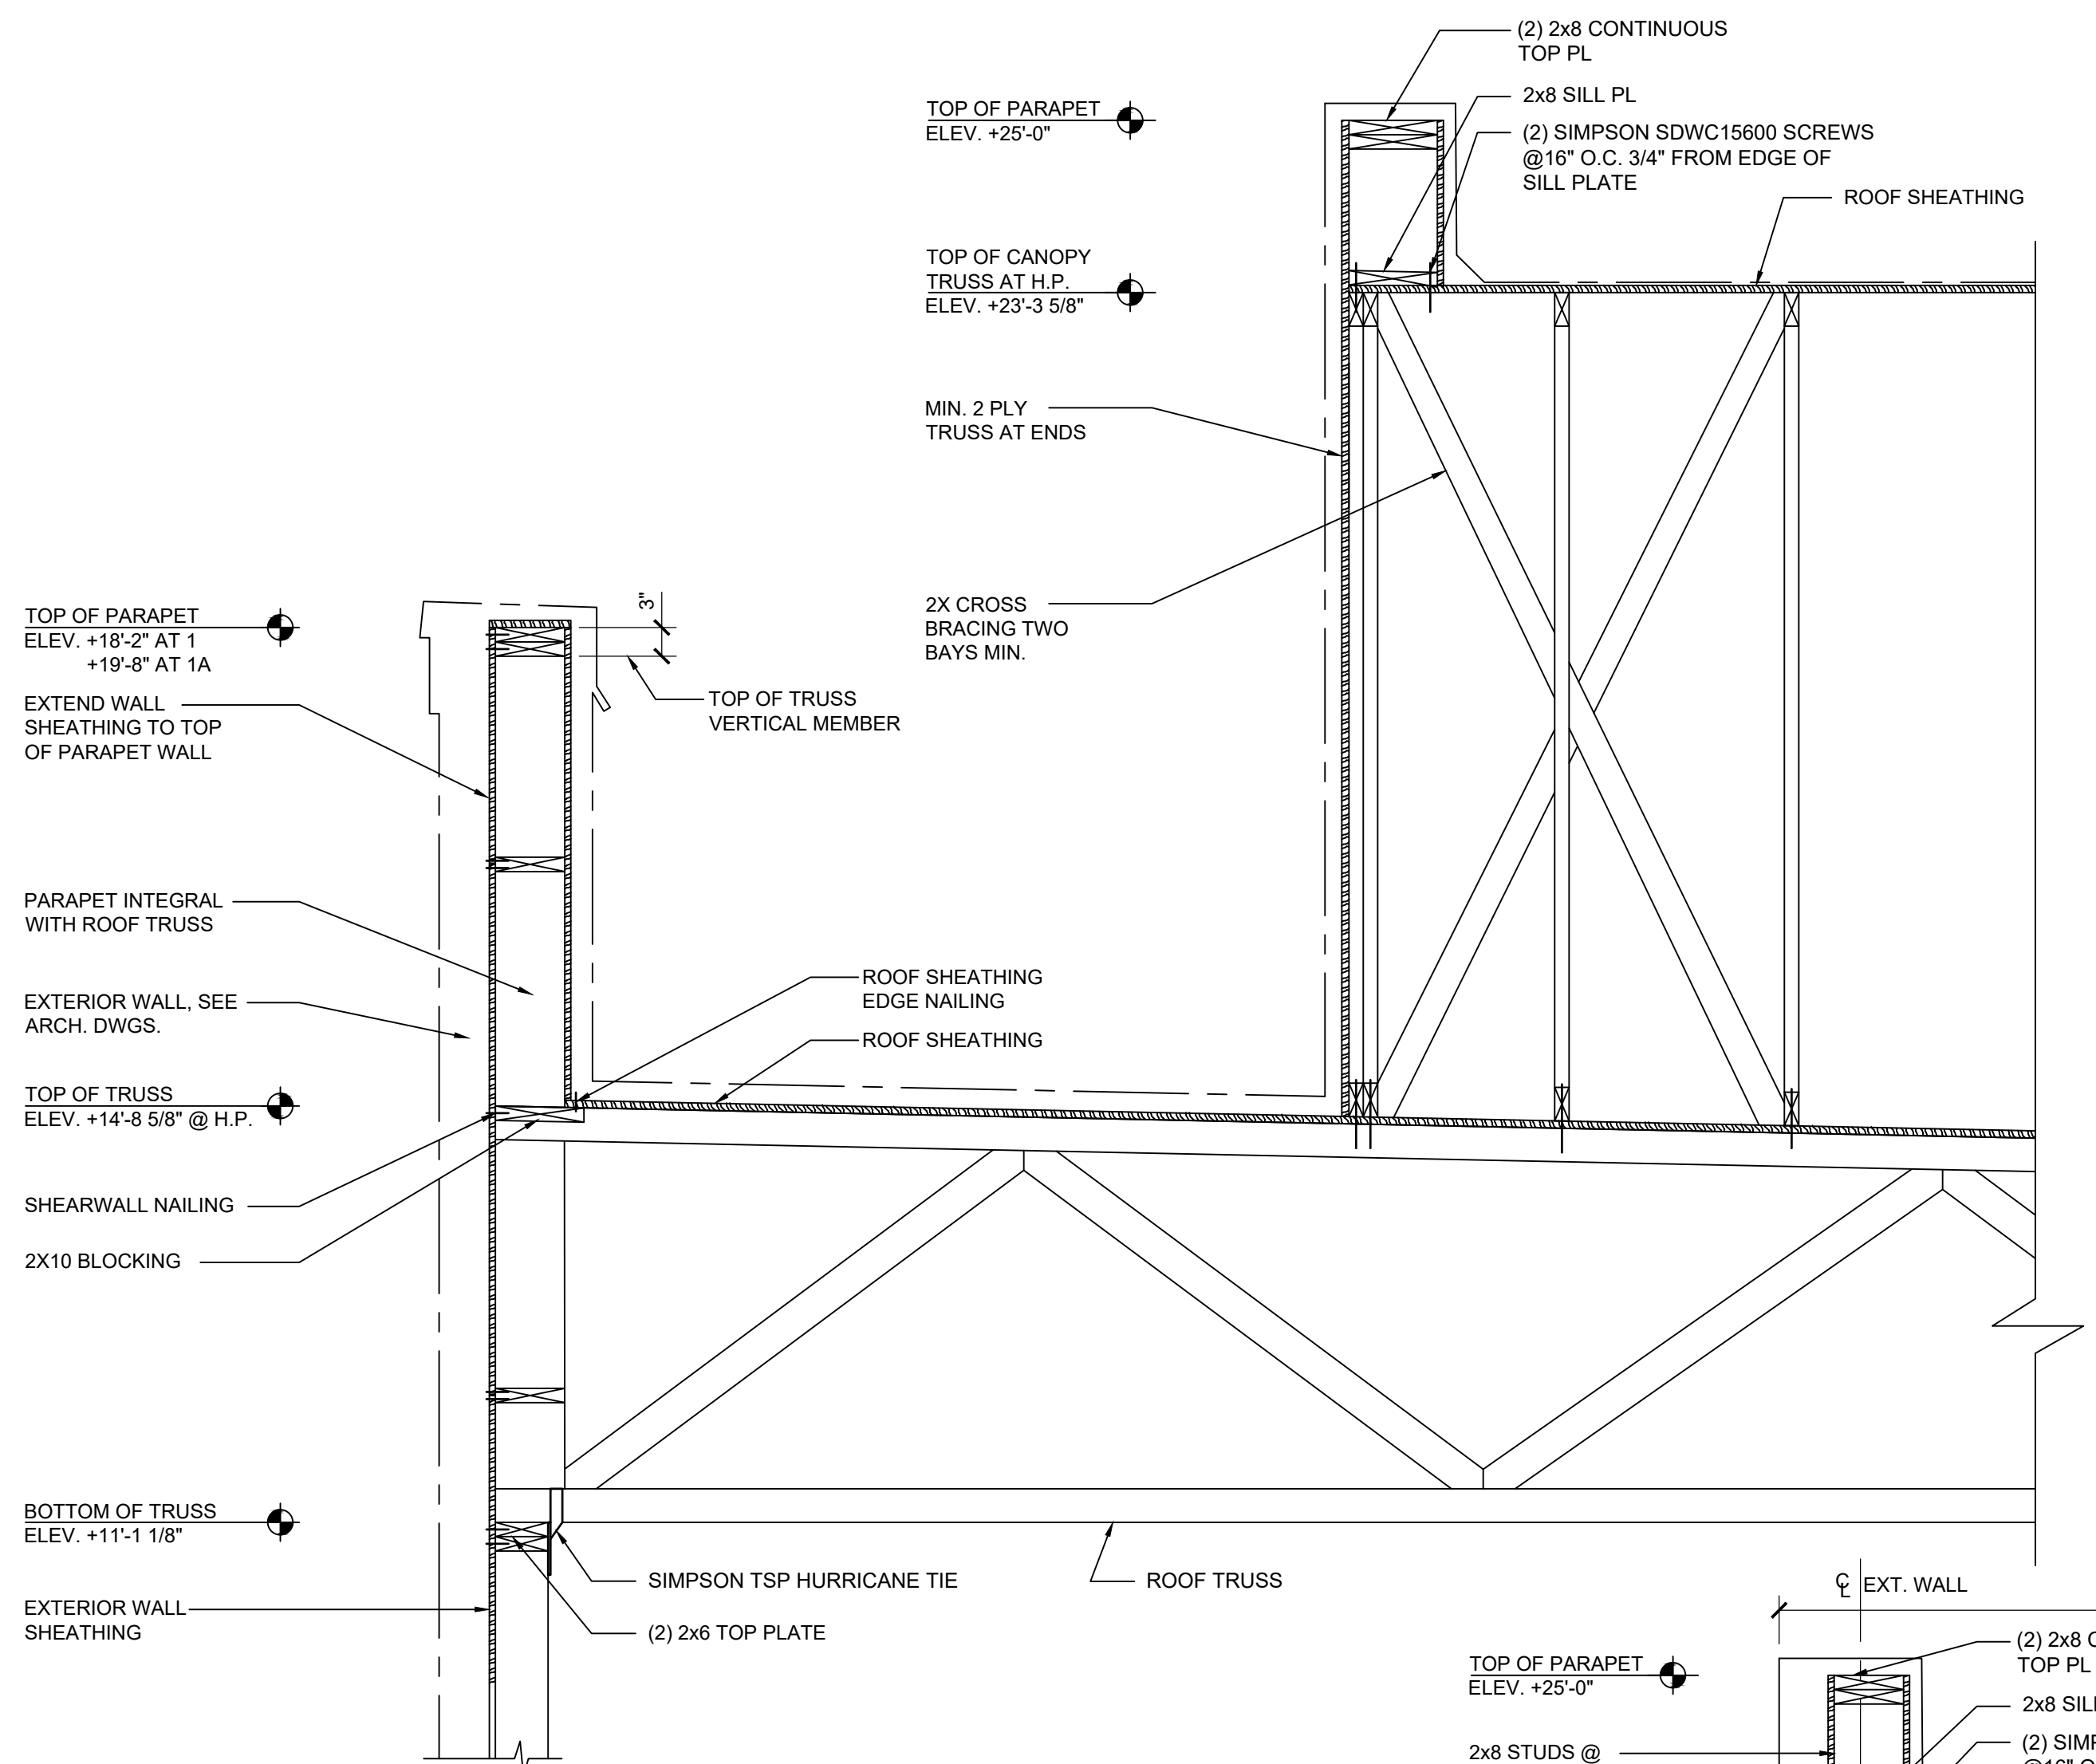

2 ROOF SECTION
SCALE: 3/4" = 1'-0"

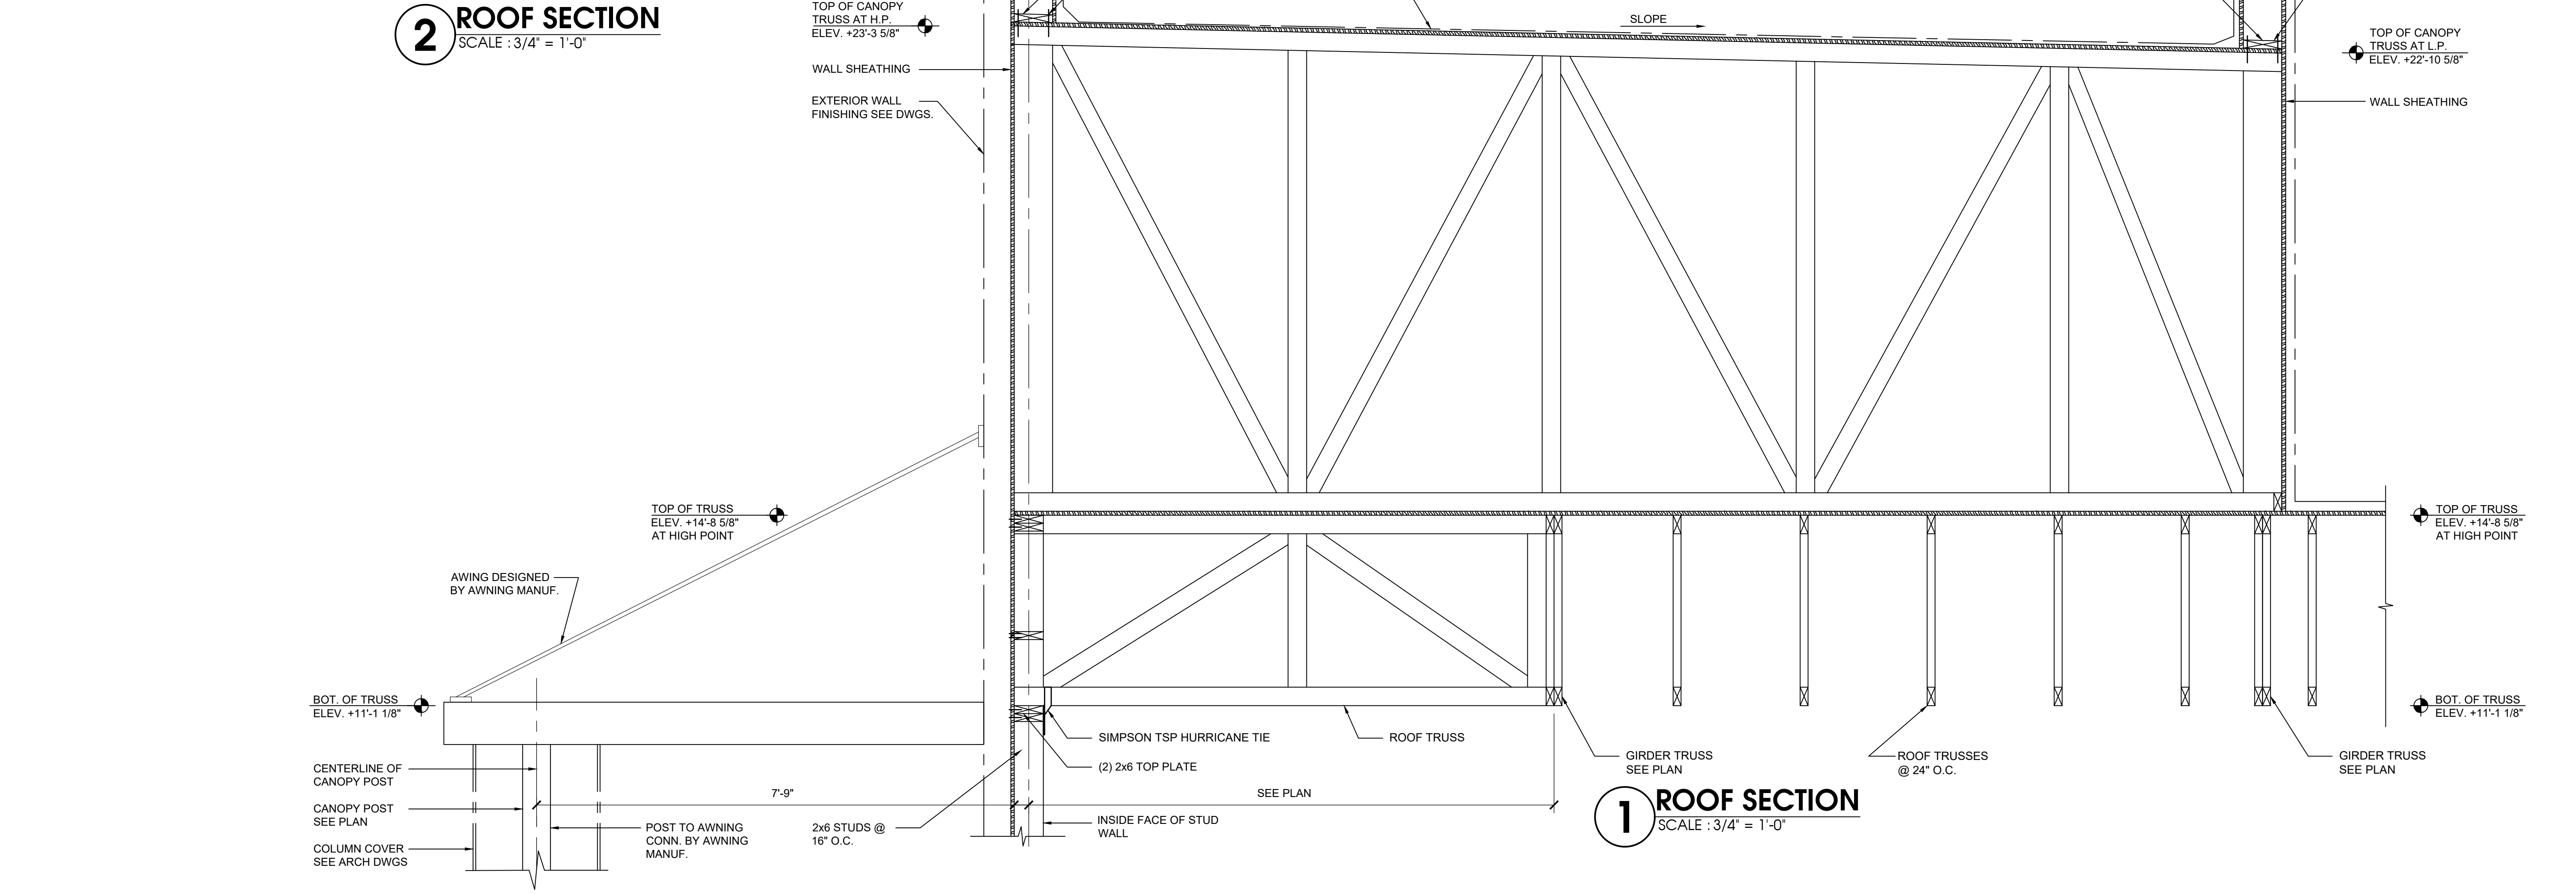


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SCALE: 3/4" = 1'-0"

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Project Number: TLEVA23-034	Scale: AS NOTED
Drawn By: R.E.	Approved By: SC

Drawing Name:

FRAMING SECTIONS

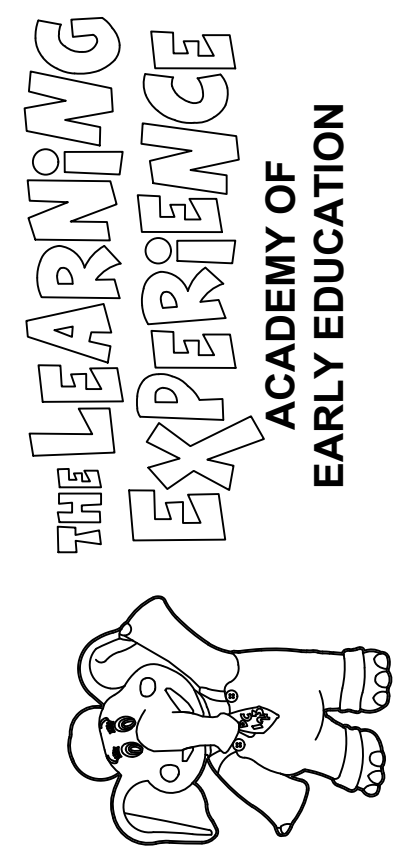Drawing Number:
S-301

SHANNON NICOLE CROWNOVER
Lic. No. 0402066228
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